
# Pittsburg Youth Development Center -HVAC Equipment Replacement

1001 Stoneman Ave Pittsburg, CA 94565

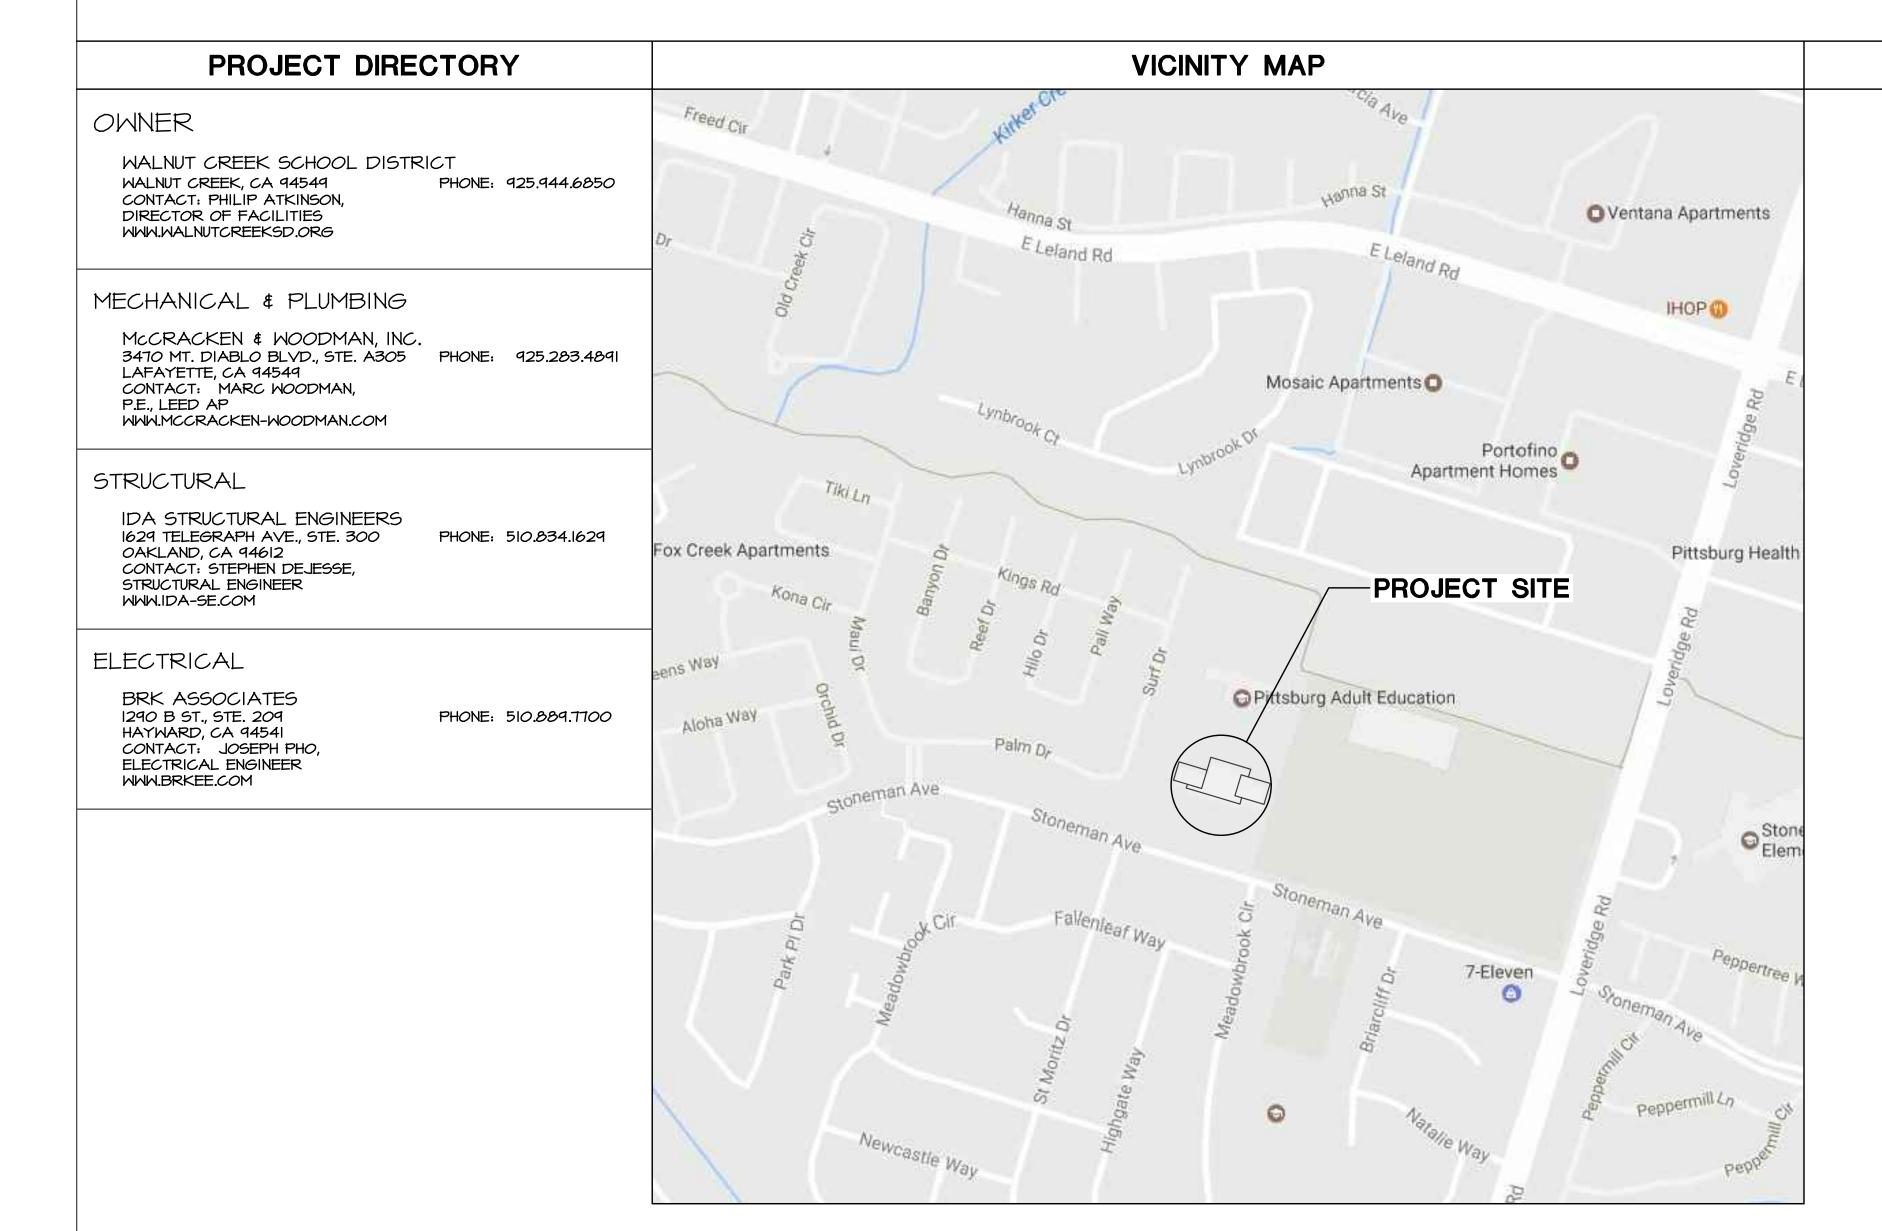

#### GOVERNMENT CODES

2016 CALIFORNIA ADMINISTRATIVE CODE

PART I, TITLE 24, CALIFORNIA CODE OF REGULATIONS (C.C.R.),

CALIFORNIA BUILDING STANDARDS COMMISSION 2016 CALIFORNIA BUILDING CODE

PART 2, TITLE 24, C.C.R.

2012 INTERNATIONAL BUILDING CODE OF THE INTERNATIONAL CODE COUNCIL, WITH CALIFORNIA AMENDMENTS

2016 CALIFORNIA ELECTRICAL CODE (CEC) PART 3, TITLE 24, C.C.R.

2011 NATIONAL ELECTRICAL CODE OF THE NATIONAL FIRE PROTECTION ASSOCIATION, NFPA

2016, MECHANICAL CODE (CMC) PART 4, TITLE 24, C.C.R.

2012 UNIFORM PLUMBING CODE OF THE INTERNATIONAL ASSOCIATION OF PLUMBING AND MECHANICAL OFFICIALS, IAPMO

2016 CALIFORNIA ENERGY CODE PART 6, TITLE 24, C.C.R.

CALIFORNIA BUILDING STANDARDS COMMISSION

2016 CALIFORNIA FIRE CODE (CFC) PART 9, TITLE 24, C.C.R.

#### PROJECT NOTES

- DRAWINGS AND SPECIFICATIONS REPRESENT FINISHED CONSTRUCTION. THE CONTRACTOR IS RESPONSIBLE FOR THE MEANS AND METHODS OF CONSTRUCTION INCLUDING BUT NOT LIMITED TO SHORING AND TEMPORARY BRACING.
- 2. THE CONTRACTOR SHALL VERIFY ALL DIMENSIONS AND CONDITIONS SHOWN ON THE DRAWINGS AND SHALL NOTIFY THE ENGINEER OF ANY DISCREPANCIES. FIGURE DIMENSIONS SHALL TAKE PRECEDENCE OVER SCALED DIMENSIONS.
- VERIFY ALL ROUGH-IN DIMENSIONS FOR EQUIPMENT PROVIDED IN THIS CONTRACT OR EQUIPMENT
- REPETITIVE FEATURES ARE NOT DRAWN IN THEIR ENTIRETY AND SHALL BE COMPLETELY
- PROVIDED AS IF DRAWN IN FULL
- ALL EXISTING WORK WHICH IS DAMAGED, CUT OR REMOVED DURING AND AS A RESULT OF WORK UNDER THIS CONTRACT, AND WHICH IS TO REMAIN IN THE COMPLETED WORK SHALL BE RESTORED. PRINCIPAL ITEMS INCLUDE THE PATCHING OF WORK CUT AS ARESULT OF THE INSTALLATION OF OR REPAIR TO MECHANICAL, PLUMBING AND ELECTRICAL SYSTEMS; AND DEMOLITION ASSOCIATED WITH REMODELING.
- WHEN SUBSTITUTIONS OR REVISION OF EITHER A DETAIL OR AN ASSEMBLY SHOWN WITH A UL, UBC, OR GA LISTING NUMBER IS PROPOSED BY THE CONTRACTOR, A SIMILAR OR EQUAL TESTING MUST BE SUBMITTED TO THE ENGINEER FOR APPROVAL BY DSA.
- 8. UNLESS OTHERWISE NOTED, PLAN DIMENSIONS ARE TO EITHER FACE OF (E) FINISH, FACE OF (N) STUDS, FACE OF CONCRETE AND CMU, OR CENTER LINE. PROVIDE AND VERIFY SIZE AND LOCATION OF THE FOLLOWING: REQUIRED ACCESS DOORS,
- OPENINGS, FURRINGS, ANCHORS, INSERTS AND BLOCKING REQUIRED FOR ACCESSORIES, AND MECHANICAL AND ELECTRICAL EQUIPMENT. CONTRACTOR IS RESPONSIBLE FOR ALL ACCESS DOORS WHETHER SHOWN OR NOT SHOWN ON DRAWINGS. 10. ALL NOTED ITEMS ARE TO BE PROVIDED NEW UNLESS NOTED AS EXISTING (E) OR OTHERWISE NOTED. REPLACE MEANS TO REMOVE EXISTING (E), IF NOT MISSING, AND PROVIDE NEW (N). U.O.N.
- INDICATED. DELIVER TO DISTRICT MEANS DELIVER TO A LOCATION ON THIS CAMPUS WHERE DIRECTED BY THE SCHOOL DISTRICT. HOLES IN WOOD FOR LAG SCREWS SHALL FIRST BE BORED TO THE SAME DIAMETER AND DEPTH AS THE SHANK. HOLES FOR THE THREADED PORTION SHALL BE BORED WITH A BIT NOT LARGER

SALVAGE MEANS TO REMOVE INTACT, DELIVER OR STORE AND PROTECT FOR RE-USE AS

- THAN THE BASE OF THE THREADS. 12. GENERAL CONTRACTORS AND ALL SUBCONTRACTORS ARE STRONGLY ADVISED TO VERIFY
- EXISTING SITE CONDITIONS PRIOR TO BID. SEE "INSTRUCTION TO BIDDERS" FOR TIME OF PRE-BID
- 13. ANY EXISTING EQUIPMENT INCLUDING BUT NOT LIMITED TO LOW YOLTAGE WIRING OR SYSTEM THAT IS DAMAGED OR LEADS TO ANY COMPONENT MALFUNCTION SHALL BE REPAIRED AT THE EXPENSE OF THE CONTRACTOR TO THE SATISFACTION OF THE SCHOOL DISTRICT. ALL EXISTING EQUIPMENT OR SYSTEMS ARE ASSUMED IN PROPER FUNCTIONING ORDER U.O.N. THE CONTRACTOR IS RESPONSIBLE FOR NOTIFYING THE THE SCHOOL DISTRICT OF ANY MALFUNCTIONING EQUIPMENT OR SYSTEMS PRIOR TO WORK IN THE AREA OF SCOPE OF WORK.
- SUBSTITUTE MATERIALS AND SYSTEMS SECTION 17(f) TITLE 21, GOVERNS AND READS IN PART. "THE ESTIMATED COST OF A PROJECT SHALL BE INCREASED AS NECESSARY TO INCLUDE THE ESTIMATED COST OF EVERY ALTERNATE BUILDING OR PORTION THEREOF SHOWN ON THE PLANS AND SPECIFICATIONS AS IF EACH ALTERNATE BUILDING AND PORTION WERE TO BE CONSTRUCTED SEPARATELY AND SIMULTANEOUSLY.

PATCHED, RECONSTRUCTED AND/OR PAINTED TO MATCH EXISTING ADJACENT SURFACE. MATCH

15. ALL REQUIRED WORK SHALL BE COMPLETED TO ENTIRETY. 16. ALL EXISTING FINISHES DISTURBED AS A RESULT OF CONSTRUCTION SHALL BE RESTORED,

PAINTING SHALL BE EXTENDED TO NATURAL BREAKS IN MATERIAL.

TITLE SHEET AND NOTES

DRAWING INDEX

#### MECHANICAL

GENERAL

MECHANICAL LEGEND AND NOTES MECHANICAL SCHEDULES

MECHANICAL DEMOLITION ROOF PLAN MECHANICAL FLOOR PLAN

MECHANICAL ROOF PLAN

MECHANICAL DETAILS

PLUMBING LEGEND AND NOTES PLUMBING DEMOLITION ROOF PLAN

P2.I PLUMBING ROOF PLAN

P3.1 PLUMBING DETAILS

#### STRUCTURAL

GENERAL NOTES, ROOF FRAMING PLAN AND DETAIL

#### ELECTRICAL

SYMBOLS, NOTES AND DIAGRAMS

E-2 POWER PLAN - GYMNASIUM AND COMMUNITY ROOM


ROOF ELECTRICAL PLAN



OWNER:

Pittsburg Unified **School District** 

2000 Railroad Avenue Pittsburg, CA 94565

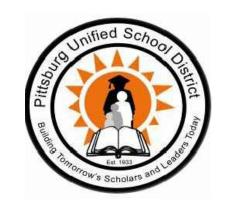


MCCRACKEN & WOODMAN

Lafayette, CA 94549

PROJECT:

Pittsburg Youth Development Center -**HVAC** Equipment Replacement

1001 Stoneman Ave Pittsburg, CA 94565

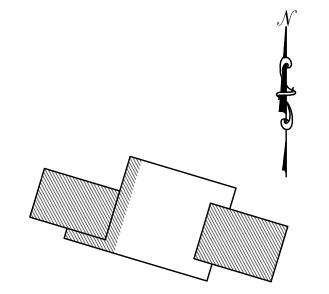

Key Plan

**REVISIONS** 

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TITLE SHEET AND NOTES

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#### MECHANICAL AND PLUMBING

#### COMPONENT ANCHORAGE NOTE

ALL MECHANICAL AND PLUMBING COMPONENTS SHALL BE ANCHORED AND INSTALLED PER THE DETAILS ON THE CONSTRUCTION DOCUMENTS. WHERE NO DETAIL IS INDICATED, THE FOLLOWING COMPONENTS SHALL BE ANCHORED OR BRACED TO MEET THE FORCE AND DISPLACEMENT REQUIREMENTS PRESCRIBED IN THE 2016 CBC, SECTIONS 1616A.I.18 THROUGH 1616A,1,26 AND ASCE 7-10 CHAPTERS 13, 26 AND 30.

- I. ALL PERMANENT EQUIPMENT AND COMPONENTS. 2. TEMPORARY OR MOVABLE EQUIPMENT THAT IS PERMANENTLY ATTACHED TO THE
- BUILDING UTILITY SERVICES SUCH AS GAS OR WATER PIPING. 3. MOVABLE EQUIPMENT WHICH IS STATIONED IN ONE PLACE FOR MORE THAN & HOURS AND HEAVIER THAN 400 POUNDS OR HAS A CENTER OF MASS LOCATED 4 FEET OR MORE ABOVE THE ADJACENT FLOOR OR ROOF LEVEL THAT DIRECTLY SUPPORT THE COMPONENT ARE REQUIRED TO BE ANCHORED WITH TEMPORARY ATTACHMENTS.

THE FOLLOWING MECHANICAL COMPONENTS SHALL BE POSITIVELY ATTACHED TO THE STRUCTURE, BUT THE ATTACHMENT NEED NOT BE DETAILED ON THE PLANS. THESE COMPONENTS SHALL HAVE FLEXIBLE CONNECTIONS PROVIDED BETWEEN THE COMPONENT AND ASSOCIATED DUCTWORK AND PIPING.

- A. COMPONENTS WEIGHING LESS THAN 400 POUNDS AND HAVE A CENTER OF MASS LOCATED 4 FEET OR LESS ABOVE THE ADJACENT FLOOR OR ROOF LEVEL THAT DIRECTLY SUPPORT THE COMPONENT.
- B. COMPONENTS WEIGHING LESS THAN 20 POUNDS, OR IN THE CASE OF DISTRIBUTED SYSTEMS, LESS THAN 5 POUNDS PER FOOT, WHICH ARE SUSPENDED FROM A ROOF OR FLOOR OR HUNG FROM A WALL.

FOR THOSE ELEMENTS THAT DO NOT REQUIRE DETAILS ON THE APPROVED DRAWINGS, THE INSTALLATION SHALL BE SUBJECT TO THE APPROVAL OF THE DESIGN PROFESSIONAL IN GENERAL RESPONSIBLE CHARGE OR STRUCTURAL ENGINEER DELEGATED RESPONSIBILITY. THE PROJECT INSPECTOR WILL VERIFY THAT ALL COMPONENTS AND EQUIPMENT HAVE BEEN ANCHORED IN ACCORDANCE WITH ABOVE REQUIREMENTS.

PIPING AND DUCTWORK SYSTEMS BRACING NOTE

PIPING AND DUCTWORK SYSTEMS SHALL BE BRACED TO COMPLY WITH THE FORCES AND DISPLACEMENTS PRESCRIBED IN ASCE 7-10 SECTION 13.3 AS DEFINED IN ASCE 7-10 SECTIONS 13.6.5.6, 13.6.7, 13.6.8, AND 2016 CBC SECTIONS 1616A.1.24, 1616A.1.25 AND

THE METHOD OF SHOWING BRACING AND ATTACHMENTS TO THE STRUCTURE FOR THE IDENTIFIED DISTRIBUTION SYSTEM ARE AS NOTED BELOW. WHEN BRACING AND ATTACHMENTS ARE BASED ON A PREAPPROVED INSTALLATION GUIDE (E.G., SMACNA OR OSHPD OPM), COPIES OF THE BRACING SYSTEM INSTALLATION GUIDE OR MANUAL SHALL BE AVAILABLE ON THE JOBSITE PRIOR TO THE START OF AND DURING THE HANGING AND BRACING OF THE DISTRIBUTION SYSTEMS. THE STRUCTURAL ENGINEER OF RECORD SHALL VERIFY THE ADEQUACY OF THE STRUCTURE TO SUPPORT THE HANGER AND BRACE LOADS.

MECHANICAL PIPING (MP), MECHANICAL DUCTS (MD) AND PLUMBING PIPING (PP):

MP - MD - PP -MP - MD - PP -

MP MD PP

OPTION I: DETAILED ON THE APPROVED DRAWINGS WITH PROJECT SPECIFIC NOTES AND DETAILS. OPTION 2: SHALL COMPLY WITH THE APPLICABLE

OSHPD PRE-APPROVAL (OPM #0052-13). OPTION 3: SHALL COMPLY WITH SMACNA SEISMIC RESTRAINT MANUAL, OSHPD EDITION (2009), INCLUDING ANY ADDENDA. FASTNERS AND OTHER ATTACHMENTS NOT SPECIFICALLY IDENTIFIED IN THE SMACNA SEISMIC RESTRAINT MANUAL, OSHPD EDITION, ARE DETAILED ON THE APPROVED DRAWINGS WITH PROJECT SPECIFIC NOTES AND DETAILS. THE DETAILS SHALL ACCOUNT FOR THE APPLICABLE SEISMIC HAZARD LEVEL AND CONNECTION LEVEL FOR THE PROJECT AND

#### SYSTEM ACOUSTICS NOTES

CONDITIONS.

- I. ALL HVAC EQUIPMENT IS TO BE ADJUSTED SO THAT IT IS OPERATING AT OR BELOW THE MANUFACTURER'S LISTED NOISE LEVELS.
- A. SINGLE PHASE MOTOR HUM IS NOT ACCEPTABLE. ANY MOTORS THAT EXHIBIT MOTOR HUM ARE TO BE REPLACED.
- B. EXCESSIVE EQUIPMENT VIBRATION IS NOT ACCEPTABLE. EQUIPMENT THAT EXHIBITS EXCESSIVE OR LOUD VIBRATIONS IS TO BE CORRECTED OR REPLACED.
- 2. ALL POSSIBLE SOURCES OF NOISE ARE TO BE REVIEWED AND ADDRESSED SO THAT THE SYSTEMS ARE OPERATING QUIETLY INCLUDING THE FOLLOWING:
- A. ALL FAN SYSTEMS INCLUDING AC UNITS, AND EXHAUST FANS ARE TO BE ADJUSTED SUCH THAT THE SYSTEMS DELIVER THE REQUIRED CFM AIRFLOW AT THEIR LOWEST POSSIBLE SPEED SETTINGS. THIS ADJUSTMENT IS TO INCLUDE DRIVE AND/OR SHEAVE CHANGES AS REQUIRED ON ANY FAN SYSTEMS THAT DO NOT MEET AIRFLOW OR ACOUSTICAL REQUIREMENTS.
- B. AIR BALANCE PROCEDURE IS TO BE AS FOLLOWS: ADJUST ALL DAMPERS IN DUCT SYSTEM TO THEIR FULL OPEN
  - 2. MEASURE AND RECORD THE TOTAL DELIVERED AIRFLOW OF
  - FAN SYSTEM.
  - 3. REDUCE FAN SPEED TO DELIVER TOTAL REQUIRED
  - CFM AIRFLOW AS SHOWN ON THE FLOOR PLANS. 4. ADJUST INDIVIDUAL BALANCING DAMPERS IN THE DUCTWORK TO PROPORTION CFM TO AIRFLOW VALUES SHOWN ON THE FLOOR PLANS.
- 3. VARY TOTAL SYSTEM AIR QUANTITIES BY ADJUSTMENT OF FAN SPEEDS. INSTALL DRIVE AND/OR SHEAVE CHANGES AS REQUIRED. VARY BRANCH AIR QUANTITIES BY DAMPER REGULATION.
- 4. AIR BALANCING OF THE DUCT SYSTEMS IS TO BE MADE SO THAT AIR NOISE IS KEPT TO A MINIMUM. AIR BALANCING IS TO BE MADE STARTING WITH THE FARTHEST REGISTER FROM THE FAN, WORKING BACK TO THE EQUIPMENT. @PINCHINGA AN IN-LINE DAMPER THAT IS CLOSE TO THE FAN IS NOT ACCEPTABLE.
- 5. BALANCING DAMPERS ARE TO BE INSTALLED IN ALL BRANCH SUPPLY, RETURN, OUTSIDE AIR, AND EXHAUST DUCTS WHETHER OR NOT SHOWN ON THE DRAWINGS. ALL BALANCING DAMPERS ARE TO BE INSTALLED IN THE WYE BRANCHES, OR IN THE BRANCH DUCT AS FAR AWAY FROM THE REGISTER OR GRILLE AS POSSIBLE. STRAIGHT RUNS OF EXPOSED DUCT WITH DUCT MOUNTED REGISTERS OR GRILLES ARE TO INCLUDE BALANCING DAMPERS AT THE MID-POINTS BETWEEN THE REGISTERS OR GRILLES. INSTALL CABLE OPERATED DAMPERS AT INACCESSIBLE AREAS.
- 6. FLEXIBLE FABRIC DUCT CONNECTORS ARE TO BE INSTALLED AT ALL CONNECTIONS TO EQUIPMENT.
- 7. FLEXIBLE ELECTRICAL AND PLUMBING CONNECTORS ARE TO BE USED AT ALL CONNECTIONS TO NON-RIGIDLY MOUNTED EQUIPMENT.
- 8. ALL ROOF, CEILING, AND WALL PENETRATIONS (DUCT AND PIPING) ARE TO BE CAULKED AND SEALED. INSULATION MAY BE USED IN CONCEALED AREAS TO FILL VOIDS. FIRE CAULK ALL PENETRATIONS THROUGH RATED WALLS WITH 3M FIRESTOPPING SYSTEMS, OR EQUAL.
- 9. COMPRESSORS ARE TO BE RELEASED FROM THEIR SHIPPING BOLTS.

#### MECHANICAL LEGEND AND ABBREVIATIONS

		141 - 41 17 41 41
	<u>SYMBOL</u>	DESCRIPTION
(5)		SWITCH OR SENSOR - MOUNT AT +48" A
T		THERMOSTAT - MOUNT AT +48" AFF
4		SHEET NOTE DESIGNATION
M		ITEM FURNISHED AND INSTALLED BY MECHANICAL CONTRACTOR
E		ITEM FURNISHED AND INSTALLED BY ELECTRICAL CONTRACTOR
P		ITEM FURNISHED AND INSTALLED BY PLUMBING CONTRACTOR
M2.I		DETAIL REFERENCE - UPPER NUMBER=DETAIL NUMBER, LOWER NUMBER=SHEET NUMBER
AC I		EQUIPMENT TAG
		EXISTING DUCT, PIPING OR EQUIPMENT TO REMAIN
4114) 4114		EXISTING DUCT, PIPING OR EQUIPMENT TO BE REMOVED

BBREVIATION	DESCRIPTION		DESCRIPTION
Φ	DIAMETER	H∉✓	HEATING & VENTILATING
	PHASE	HT.	HEIGHT
	AIR CONDITIONING	HVAC	HEATING, VENTILATING AND AIR CONDITIONING
	ABOVE FINISHED FLOOR	IFC	IN FURRED CEILING
	ALTERNATE	IN.	INCH, INCHES
	ACCESS PANEL	LBS., #	POUNDS
	APPROXIMATE	LAN	LOCAL AREA NETWORK
	BOTTOM OF DUCT	LV6.	LEAVING
	BELOW FLOOR	MAT'L, MATL.	MATERIAL
	BELOW GRADE	MAX.	MAXIMUM
	BUILDING	MBH	I,000 BTU/HR.
	CUBIC FEET PER MINUTE	MECH.	MECHANICAL
	CIRCUIT	MED.	MEDIUM
4	CENTERLINE	MFG.	MANUFACTURER
-	CEILING	MIN.	MINIMUM
	CONCRETE	MIN.	MINUTE
	CONNECTION	MTD.	MOUNTED
	CONTINUATION	(N)	NEW
	CONTRACTOR	NC	NORMALLY CLOSED
CTE	CONNECT TO EXISTING	NIC, N.I.C.	NOT IN CONTRACT
	DEGREE	NO	NORMALLY OPEN
	DOUGLAS FIR	OC	ON CENTER
	DIAMETER	O.D.	OUTSIDE DIAMETER
	DIMENSION	OPNG.	OPENING
	DIVISION	05A	OUTSIDE AIR
	DOWN	PC	PLUMBING CONTRACTOR
	DRAWING	PCF	POUNDS PER CUBIC FOOT
	DRAWINGS	PLMB.	PLUMBING
	DIRECT EXPANSION	POC	POINT OF CONNECTION
	EXISTING	PRESS.	PRESSURE
	ENTERING AIR TEMPERATURE	PSI	POUNDS PER SQUARE INCH
	ELECTRICALLY COMMUTATED MOTOR	R	RADIUS
	EFFICIENT, EFFICIENCY	REF.	REFERENCE
	ELECTRICAL	REQD.	REQUIRED
	ELECTRICAL CHARACTERISTICS	REV.	REVISION
		RHWS	ROUND HEAD WOOD SCREWS
	ELEVATION	SED	SEE ELECTRICAL DRAWINGS
	EMBEDMENT	SENS.	SENSIBLE
	ENTERING	SF, S.F.	SQUARE FEET
	EQUAL	SIM	SIMILAR
	EXHAUST	SM	SHEET METAL
	EXISTING	SPD	SEE PLUMBING DRAWINGS
FF, F.F.	FINISHED FLOOR	55	STAINLESS STEEL - TYPE 316 UNO
FT.	FEET DED GEGOVE	STL.	STEEL
FPS	FEET PER SECOND	TD	TOP OF DUCT
GA.	GAUGE	TYP.	TYPICAL
GAL.	GALLON	UL, U.L.	UNDERWRITERS' LABORATORY
<i>6</i> C	GENERAL CONTRACTOR	UNO	UNLESS NOTED OTHERWISE
65M	GALVANIZED SHEET METAL	VIF	VERIFY IN FIELD
GYP. BD.	GYPSUM BOARD	MG	WATER GAGE
		W.O.G.	WATER OIL GAS
		МÞ	WATERPROOF

#### MECHANICAL LIST OF DRAWINGS

WATERPROOF

- MECHANICAL LEGEND AND NOTES MO.2 MECHANICAL SCHEDULES
- MECHANICAL DEMOLITION ROOF PLAN
- MECHANICAL FLOOR PLAN MECHANICAL ROOF PLAN
- MECHANICAL DETAILS

MCCRACKEN & WOODMAN

Lafayette, CA 94549

FAX 925-283-4892



OWNER:

Pittsburg Unified **School District** 


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PROJECT:

Pittsburg Youth Development Center -**HVAC** Equipment Replacement

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Key Plan


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MECHANICAL LEGEND AND NOTES

SHEET NUMBER

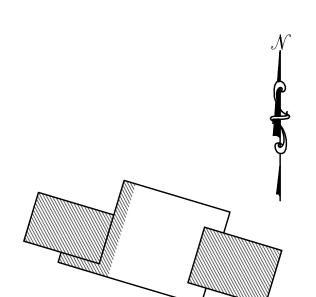

12345

AIR CONDITIONING UNIT NOTES:

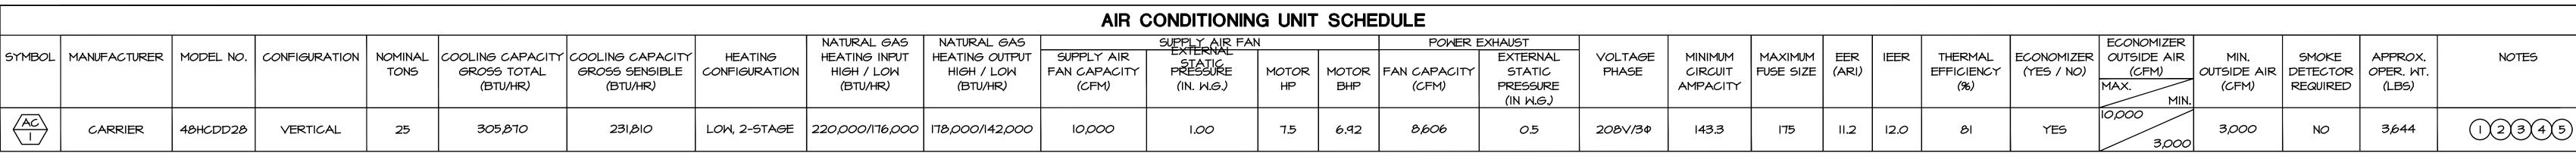I. THE AIR CONDITIONING UNIT LISTED ABOVE IS TO INCLUDE THE FOLLOWING FEATURES:

A. HIGH EFFICIENCY UNIT.

B. BASE ELECTOMECHANICAL CONTROLS. VERIFY UNIT CONTROLS ARE COMPATIBLE WITH (E) THERMOSTAT.

C. TWO-STAGE COMPRESSORS.

D. COMPRESSOR(S) TO HAVE STANDARD FIVE (5) YEAR FACTORY WARRANTY. E. LOW AMBIENT COOLING TO 35°F.

F. 2" FILTER RACK WITH 2" THROWAWAY FILTERS ARE PROVIDED WITH THE UNIT. REPLACE WITH MERV-II FILTERS AFTER COMPLETION OF START-UP AND AIR BALANCING.

G. U.L. LISTED AND LABELED.

H. FOIL FACED AND EDGE CAPTURED INSULATION.

I. HIGH AND LOW PRESSURE CONTROL, PHASE MONITORING PROTECTION.

J. CALIFORNIA COMPLIANT, INCLUDING LOW NOX. K. ANTI-SHORT CYCLE TIMER AND TIME DELAY BETWEEN COMPRESSORS.

L. FROSTAT AND CRANKCASE HEATERS.

M. HINGED ACCESS DOORS.

N. BELT DRIVE, INDOOR FAN MOTOR WITH FACTORY INSTALLED AND WIRED VFD.

O. ASHRAE 90.1 COMPLIANT.

2. MICROMETL OR EQUAL LOW LEAK CA TITLE 24 FULLY MODULATING O-100% ECONOMIZER WITH CA TITLE 24 FAULT DETECTION AND DIAGNOSTICS. ECONOMIZER IS TO HAVE FIXED DRY BULB CONTROL.

PROVIDE 100% SHUT-OFF WHEN UNIT IS OFF LINE. ECONOMIZER IS TO BE FIIELD INSTALLED IN COMPLETE ACCORDANCE WITH MANUFACTURER'S INSTALLATION INSTRUCTIONS FOR VERTICAL INSTALLATION.

3. MICROMETL PCD-MRT69TA-D000-2M4 OR EQUAL MODULATING POWER EXHAUST. 208/34, TWO -2 HP MOTORS, II.2 FLA, I4.0 MCA, I8.2 MOCP. A SEPARATE POWER SUPPLY IS REQUIRED FOR THE POWER EXHAUST. POWER EXHAUST IS TO BE FIELD INSTALLED IN COMPLETE ACCORDANCE WITH THE MANUFACTURER'S INSTALLATION INSTRUCTIONS INCLUDING INSTALLATION OF ROOM PRESSURE SENSOR TUBING.

4. PROVIDE AND INSTALL A TRANSITION CURB FROM THE EXISTING ROOF CURB TO THE NEW AIR CONDITIONING UNIT. CONTRACTOR IS RESPONSIBLE FOR FIELD VERIFICATION OF THE EXISTING ROOF CURB

AND SUPPLY AND RETURN OPENING DIMENSIONS AND FOR PROVIDING THE CORRECT TRANSITION CURB REQUIRED. 5. PROVIDE MANUFACTURER'S FULLY PROGRAMMALBE THERMOSTAT, TO BE PROGRAMMABLE BOTH AT THERMOSTAT AND USING WI-FI, CAPABLE OF CONTROLLING FAN FOR CONTINUOUS OPERATION DURING

OCCUPIED HOURS AND ALL HEATING AND COOLING STAGES. THERMOSTAT IS TO MEET REQUIREMENT OF 2016 CA TITLE 24. SET OCCUPANCY SCHEDULE TO MEET THE TENANT'S REQUIREMENTS.

	HEATING AND VENTILATING UNIT SCHEDULE										
SYMBOL	MANUFACTURER	MODEL	GAS INPUT (MBH)	HEAT OUTPUT (MBH)	SUPPLY AIR QUANTITY (CFM)	OUTSIDE AIR QUANTITY (CFM)	EXTERNAL STATIC PRESSURE (IN.)	MOTOR HP	VOLTAGE/ PHASE	APPROX. OPER. WT. (LBS)	NOTES
F	REZNOR	RPB-250	230	184	3,700	1,500	0.2	1.5	208V/3¢	1,000	() THRU (II)
(F) 2	REZNOR	RPB-250	230	184	3,700	1500	0.2	1.5	208V/3¢	1,000	() THRU (I)
F 3	REZNOR	RPB-250	230	184	3,700	1500	0.2	I.5	2 <i>08</i> V/3¢	1,000	() THRU (I)
F 4	REZNOR	RPB-250	230	184	3,700	1,500	0.2	1.5	208V/3¢	1,000	() THRU (I)

#### HEATING AND VENTILATING UNIT NOTES:

I. POWER VENTED UNIT WITH SINGLE STAGE GAS VALVE. 2. 409 STAINLESS STEEL HEAT EXCHANGER, BURNERS AND DRIP PAN.

3. MANUAL RETURN AIR DAMPER.

4. MOTORIZED 100% OUTSIDE AIR DAMPER TO BE SET FOR OUTSIDE AIR QUANTITY SHOWN WHEN UNIT IS OPERATING

AND TO BE FULLY CLOSED WHEN UNIT IS SHUT OFF.

5. 100% OUTSIDE AIR RAIN BAFFLED INTAKE HOOD. 6. 2" FILTER RACK WITH 2" THROWAWAY FILTERS ARE PROVIDED WITH THE UNIT. REPLACE WITH MERY-II FILTERS AFTER

COMPLETION OF START-UP AND AIR BALANCING. 7. TEFC FAN MOTOR WITH MOTOR STARTER.

8. UL LISTED.

9. UNIT IS TO BE DERATED TO GAS INPUT AND OUTPUT SHOWN TO MATCH (E) UNIT TO BE REPLACED.

IO. (N) UNIT IS TO BE A DIRECT REPLACEMENT OF (E) UNIT. (N) UNIT IS TO MOUNT ON (E) ROOF CURB AND SUPPLY AND RETURN OPENINGS AT (N) UNIT ARE TO LINE UP EXACTLY WITH SUPPLY AND RETURN OPENINGS AT (E) ROOF CURB.

MECHANICAL CONTRACTOR IS TO CONFIRM (N) UNIT IS A DIRECT REPLACEMENT OF (E) UNIT PRIOR TO SUBMITTING.

II. UNIT IS TO BE CONTROLLED FROM (E) TIMER SWITCH. SUPPLY FAN IS TO BE ENERGIZED AT ANY TIME TIMER SWITCH IS TURNED FOR UNIT OPERATION. UNIT IS TO HAVE FACTORY MOUNTED THERMOSTAT IN RETURN AIR SECTION FOR CONTROL OF HEATING, SET FOR 70°F.

OWNER:

Pittsburg Unified **School District** 

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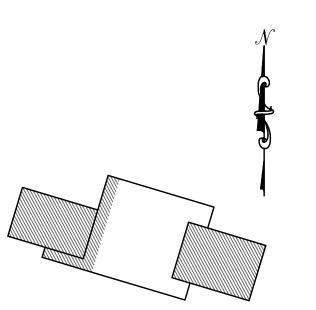
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**MECHANICAL SCHEDULES** 

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1717

- I. REMOVE (E) AC UNIT, POWER EXHAUST AND ALL RELATED ACCESSORIES IN PREPARATION FOR THE INSTALLATION OF A (N) AC UNIT AND TRANSITION CURB MOUNTED TO THE (E) ROOF CURB.
- (E) CONTROL WIRING IS TO BE PROTECTED FOR CONTROL OF (N) AC UNIT.
- 3. REMOVE (E) HEATING AND VENTILATING UNIT AND ALL RELATED ACCESSORIES IN PREPARATION FOR THE INSTALLATION OF A (N) HEATING AND VENTILATING UNIT MOUNTED TO THE (E) ROOF CURB.
- (E) CONTROL WIRING IS TO BE PROTECTED FOR CONTROL OF (N) HEATING AND VENTILATING UNIT.



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OWNER:

# Pittsburg Unified School District


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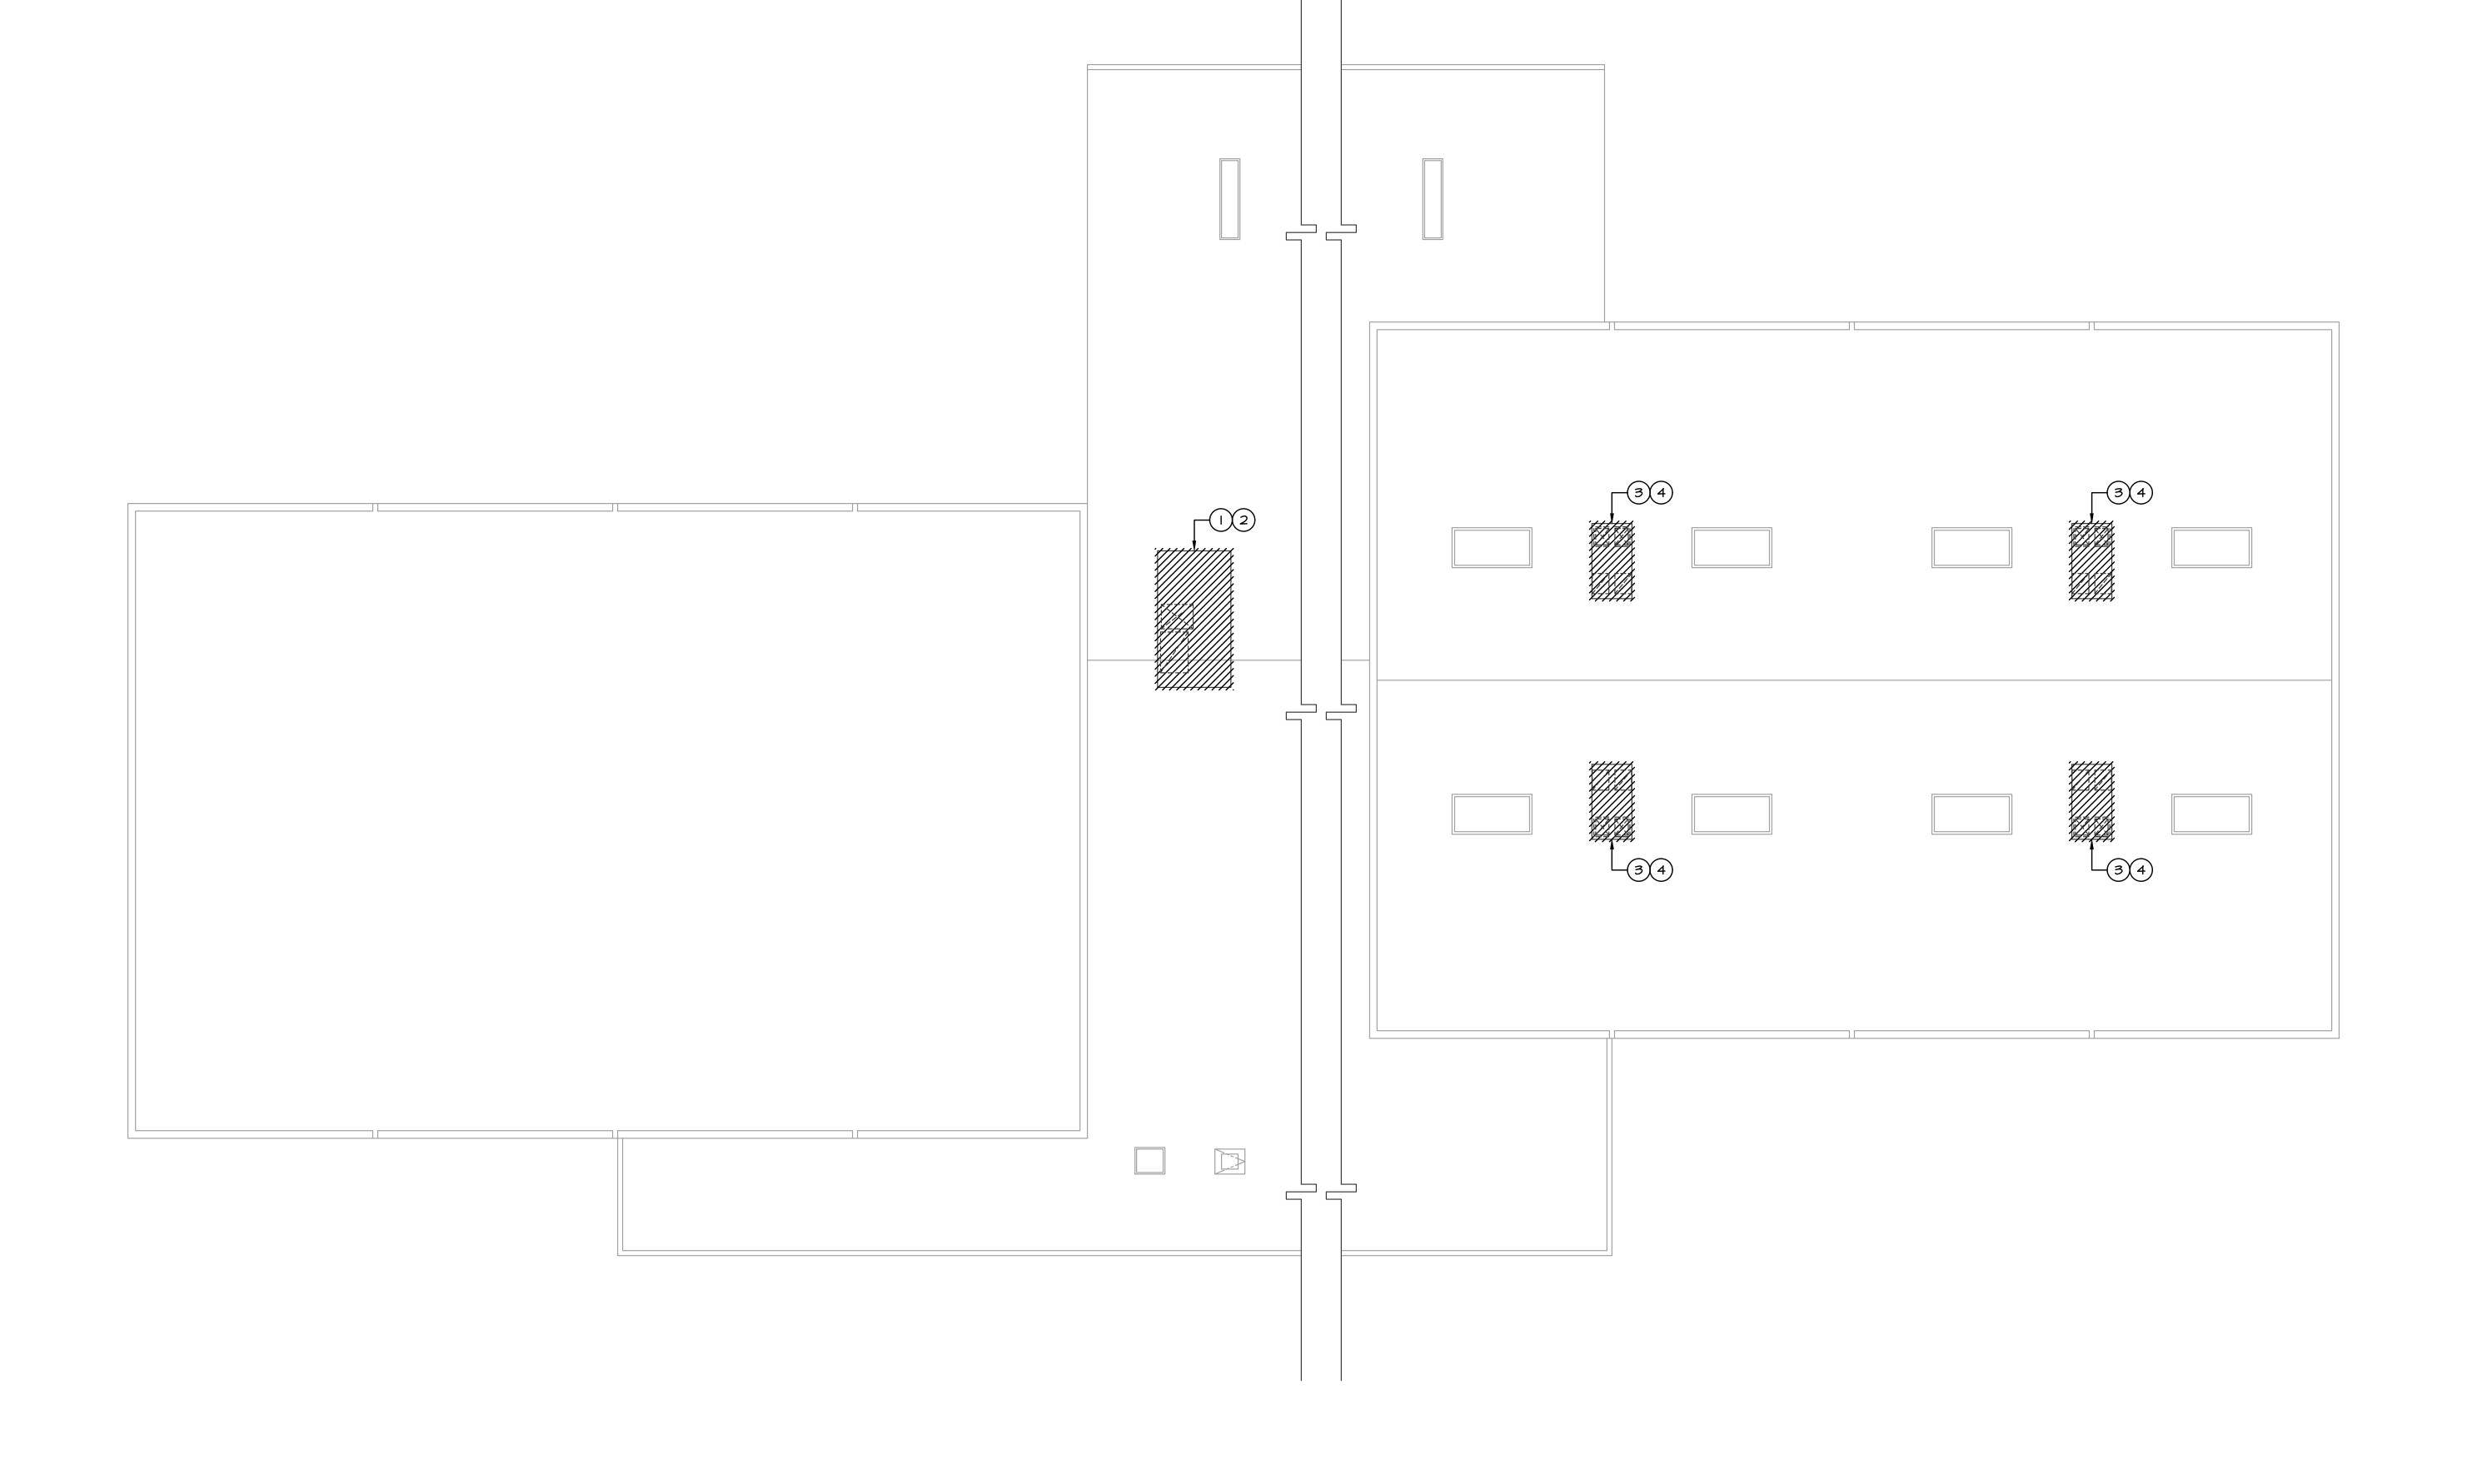
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N	1717

MECHANICAL DEMOLITION ROOF PLAN

SHEET NUMBER

M1.1

SHEET TITLE

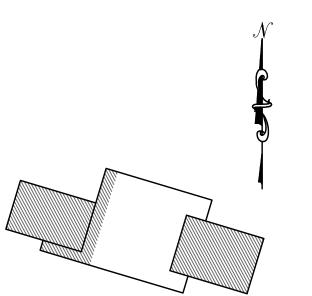

- I. AIR BALANCE (E) SIDE-DUCT MOUNTED SUPPLY AIR REGISTER TO (N) AIR QUANTITY SHOWN.
- AIR BALANCE (E) SUPPLY AIR DIFFUSER TO (N) AIR QUANTITY SHOWN.
- AIR BALANCE (E) RETURN GRILLE TO (N) AIR QUANTITY SHOWN.
- 4. (E) TRANSFER AIR GRILLES AND DUCT TO REMAIN WITHOUT MODIFICATION.
- 5. REPLACE (E) THERMOSTAT WITH (N) THERMOSTAT IN (E) LOCKING COVER. USE (E) CONTROL WIRING AND BYPASS TIMER AND CONNECT TO (N) THERMOSTAT. VERIFY (N) AC UNIT IS OPERATING CORRECTLY FROM (N) THERMOSTAT AND (E) BYPASS TIMER.



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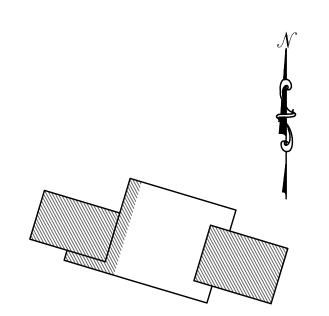
2000 Railroad Avenue Pittsburg, CA 94565



PROJECT:

Pittsburg Youth Development Center -HVAC Equipment Replacement

1001 Stoneman Ave Pittsburg, CA 94565



Key Plan

DATE

REVISIONS


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**MECHANICAL** FLOOR PLAN

SHEET NUMBER

SHEET TITLE

**M2.1** 

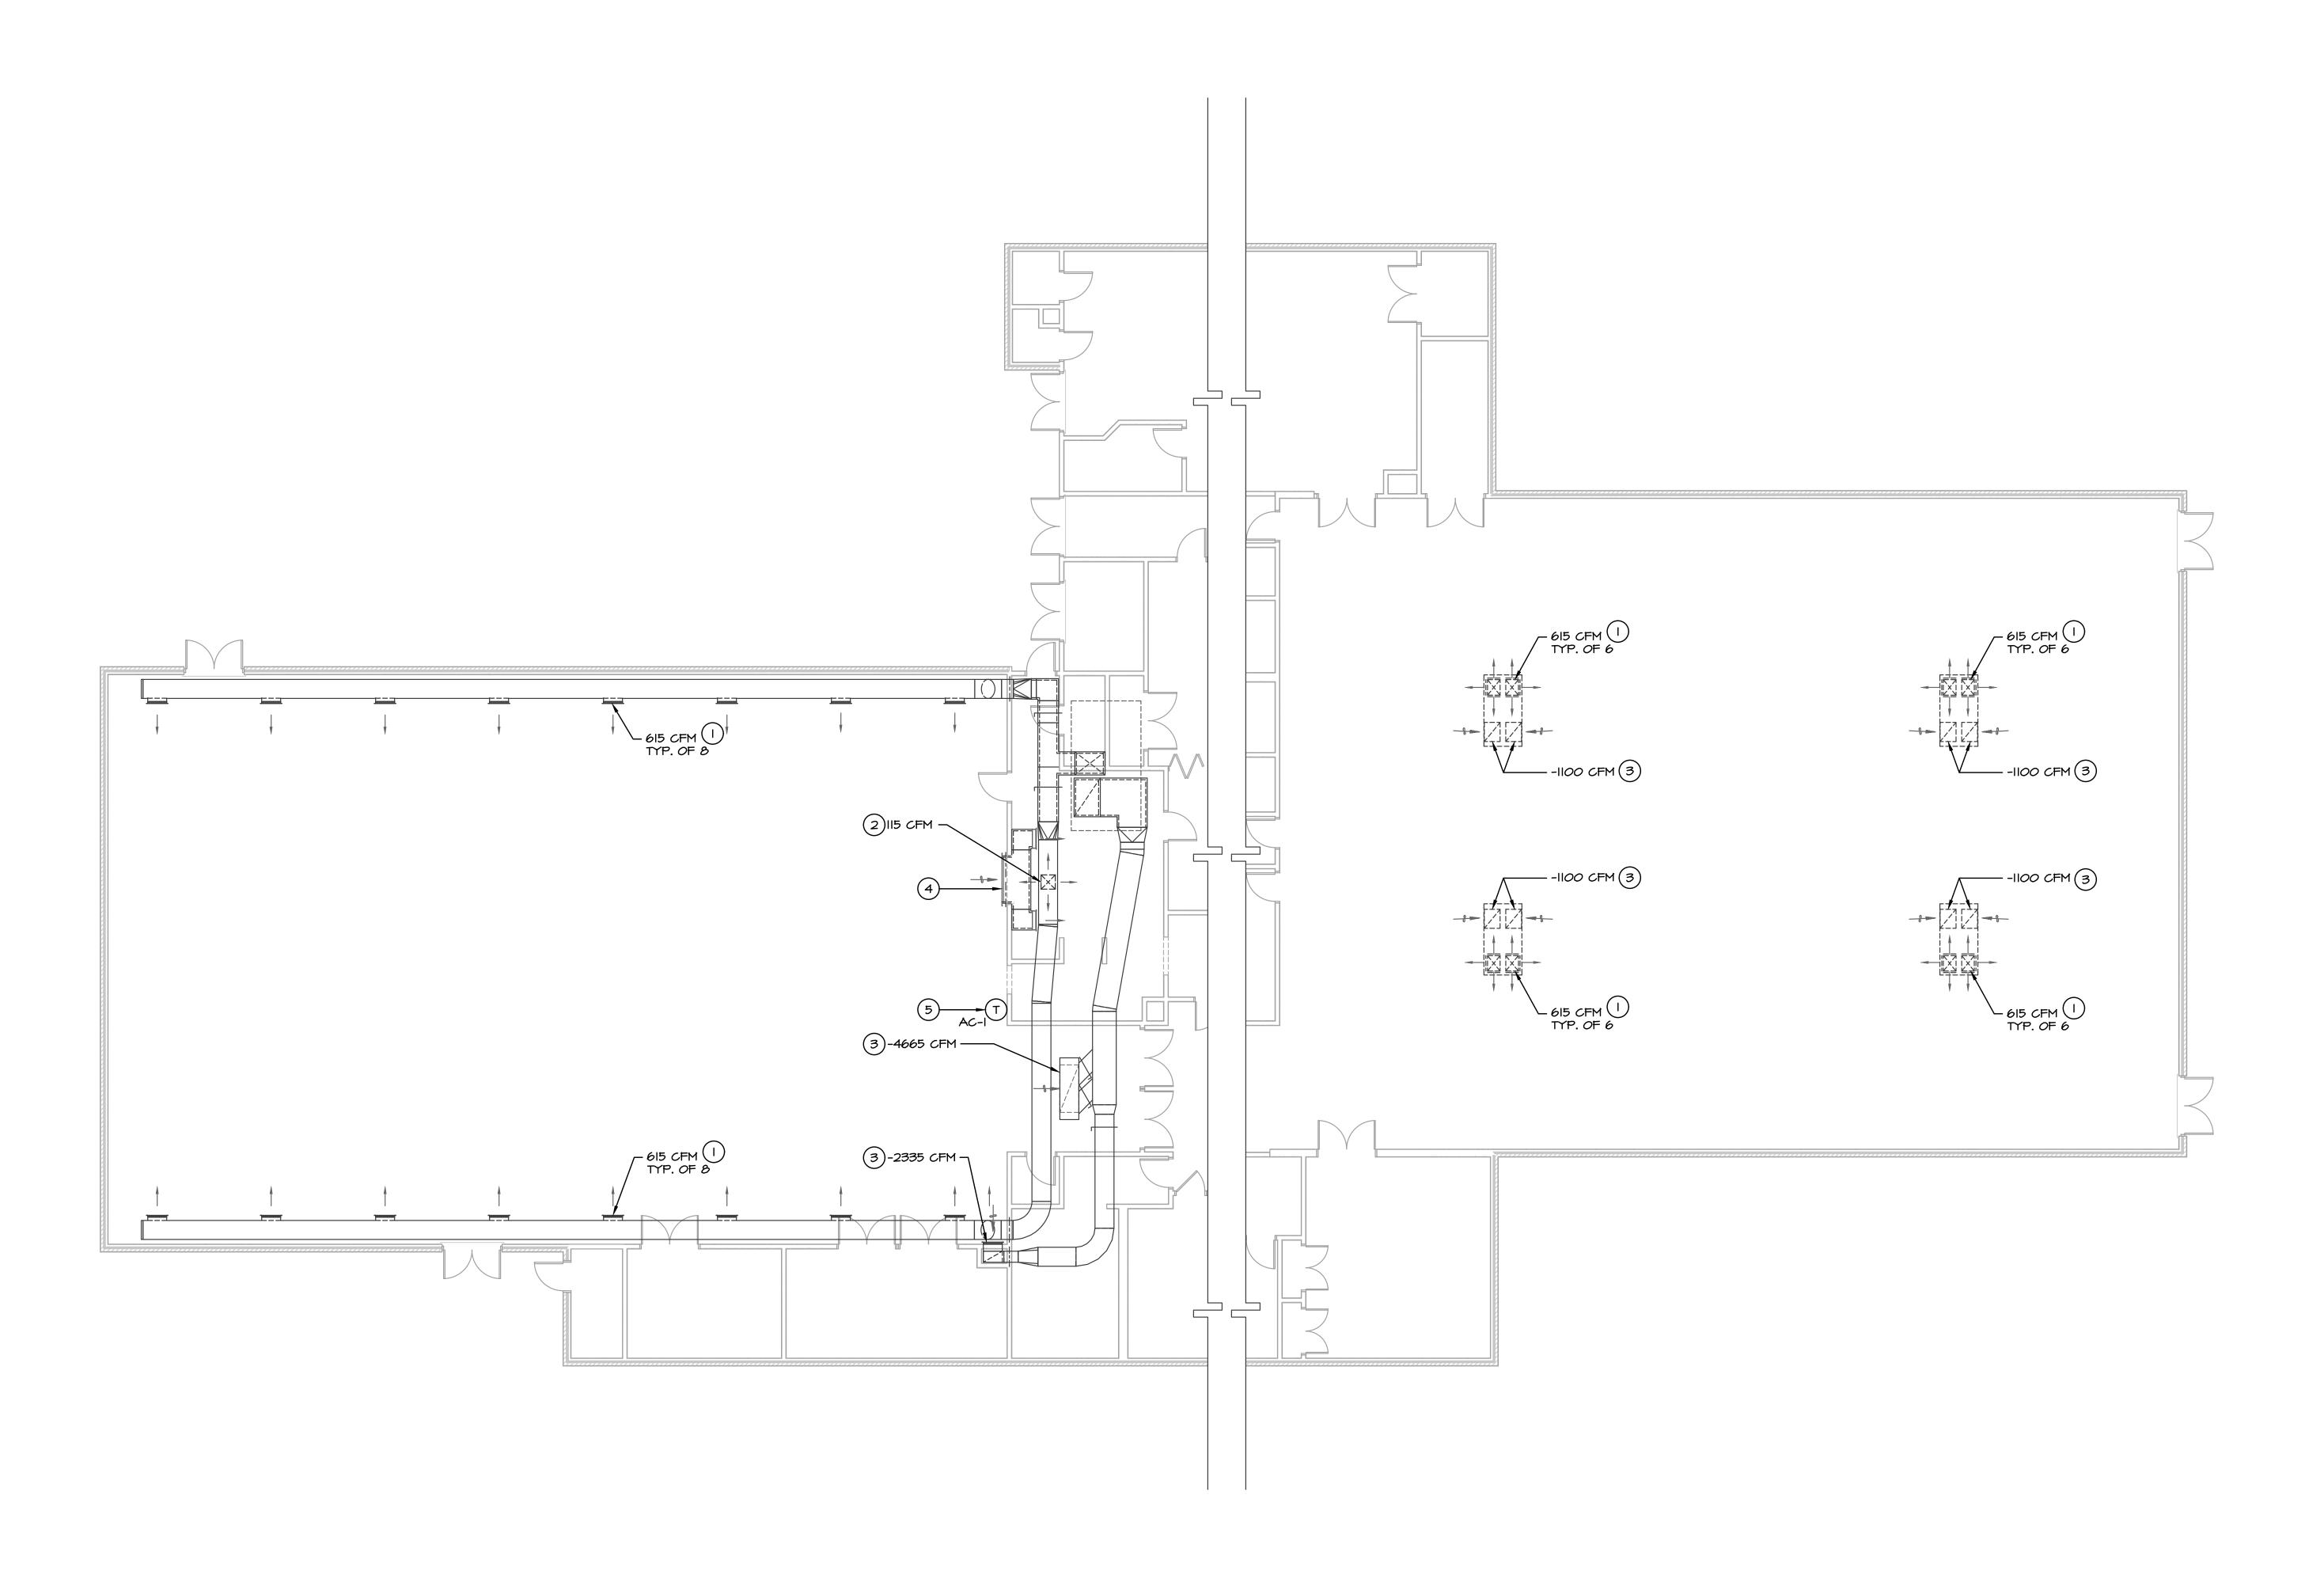

MECHANICAL FLOOR PLAN

SCALE: 1/8" = 1'-0"



MECHANICAL ROOF PLAN

SCALE: 1/8" = 1'-0"




#### SHEET NOTES

- I. (N) TRANSITION CURB AND (N) AC UNIT ARE TO BE MOUNTED TO (E) ROOF CURB. REFER TO STRUCTURAL DRAWING S-I FOR ATTACHMENT OF (N) TRANSITION CURB TO (E) ROOF CURB. ATTACH AC UNIT TO TRANSITION CURB IN ACCORDANCE WITH MANUFACTURER'S INSTALLATION INSTRUCTIONS. PROVIDE FLASHING AND COUNTERFLASHING AS REQUIRED FOR A COMPLETE WEATHERPROOF INSTALLATION.
- 2. (N) AC UNIT CONTROL IS TO BE FROM A (N) FULLY PROGRAMMABLE WI-FI THERMOSTAT USING (E) CONTROL WIRING AND OFF HOURS OPERATION FROM (E) BYPASS TIMER, PROVIDE CONTROL WIRING AS REQUIRED AND PROGRAM THERMOSTAT BASED ON THE TENANT'S HOURS OF OPERATION.
- 3. CONNECT 3/16" TUBING TO POWER EXHAUST PRESSURE TRANSDUCER ROOM PRESSURE SENSOR LOCATION. EXTEND TUBING IN I" CONDUIT ABOVE ROOF, ELBOW UP TO 12" ABOVE LOW ROOF AND STUB TUBING THRU WALL TO SENSE PRESSURE IN ROOM. CONDUIT IS TO BE PROVIDED BY ELECTRICAL CONTRACTOR, SEE ELECTRICAL DRAWINGS. FOR MOUNTING OF CONDUIT ON ROOF SEE 3/M3.I. SEAL CONDUIT PENETRATIONS AT AC UNIT AND EXTERIOR WALL AIR AND WATERTIGHT. PATCH AND REPAIR EXTERIOR WALL PENETRATION AND PAINT TO MATCH ADJACENT SURFACES AT EXTERIOR AND INTERIOR SIDES OF WALL.
- 4. (N) H&V UNIT IS TO BE MOUNTED TO THE (E) ROOF CURB, SEE I/M3.I. PROVIDE FLASHING AND COUNTERFLASHING AS REQUIRED FOR A COMPLETE WEATHERPROOF INSTALLATION.
- 5. FOR (N) H&V UNIT CONTROL SEE 2/M3.1.
- 6. INSTALL, WIRE AND COMMISSION FIELD INSTALLED ECONOMIZER AND MODULATING POWER EXHAUST AT AC UNIT IN COMPLETE ACCORDANCE WITH THE MANUFACTURER'S INSTALLATION INSTRUCTIONS. POWER EXHAUST TO BE SECURELY MOUNTED TO UNIT SUCH THAT SUPPORT LEGS ARE NOT NECESSARY AND ARE NOT TO BE INSTALLED.



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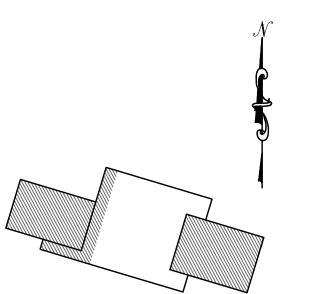
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Replacement
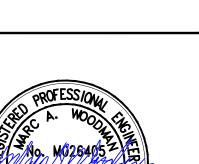
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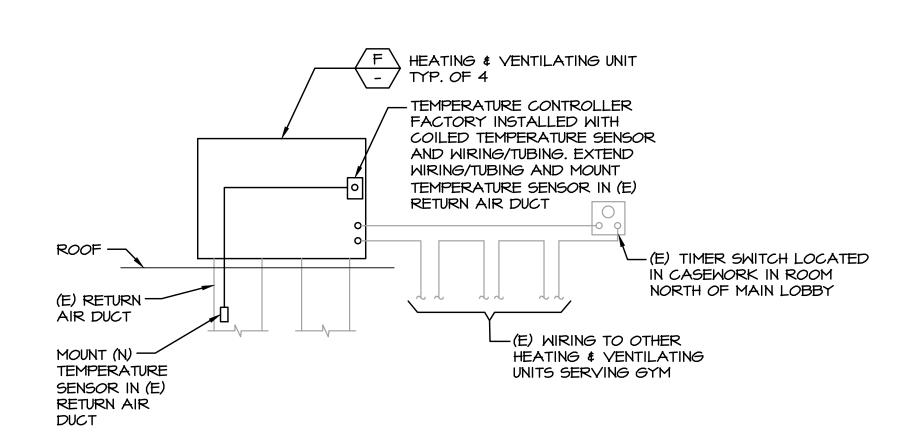
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MECHANICAL ROOF PLAN

SHEET NUMBER

M2.2




#### HEATING & VENTILATING UNIT CONTROL DIAGRAM

2 M3.I

HEATING AND VENTILATING CONTROL NOTES:


NO SCALE

- (E) TIMER SWITCH AND WIRING FOR GYM IS TO ENERGIZE SUPPLY FAN AT EACH HEATING AND VENTILATING UNIT, TYP. OF 4, FOR DURATION SET AT TIMER SWITCH.
- 2. EACH HEATING AND VENTILATING UNIT IS TO HAVE A FACTORY MOUNTED TEMPERATURE CONTROLLER WITH COILED WIRING/TUBING AND SENSOR. THE CONTRACTOR IS TO EXTEND WIRING/TUBING AND MOUNT THE SENSOR IN THE (E) RETURN DUCT.
- 3. THE TEMPERATURE CONTROLLER IN EACH HEATING AND VENTILATING UNIT IS TO CONTROL THE UNIT HEATING AND DETERMINE IF HEATING IS REQUIRED AND, IF SO, WHAT HEATING STAGES ARE TO BE FIRED. INITIALLY, SET EACH TEMPERATURE CONTROLLER FOR 72°F.

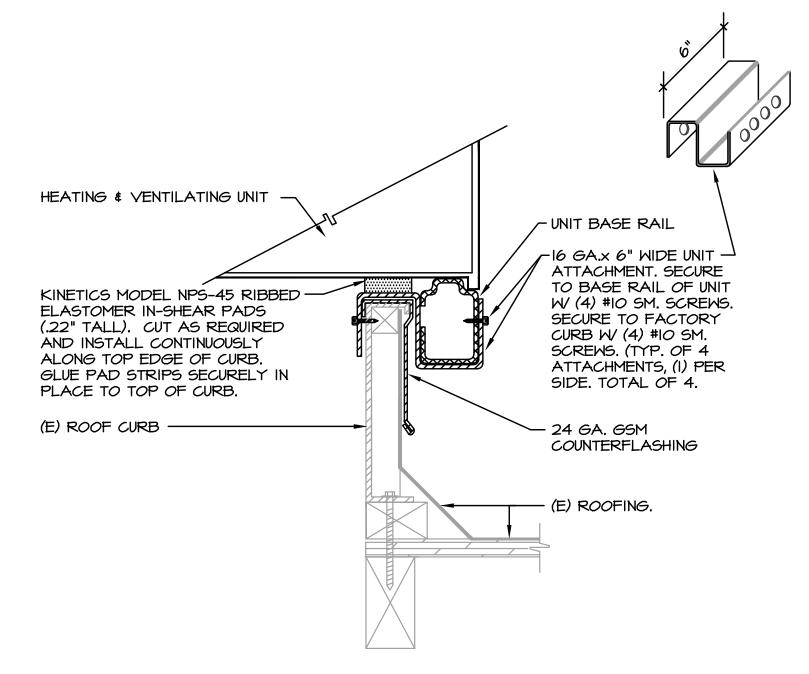

HEATING & VENTILATING UNIT CURB MOUNTING DETAIL
NO SCALE



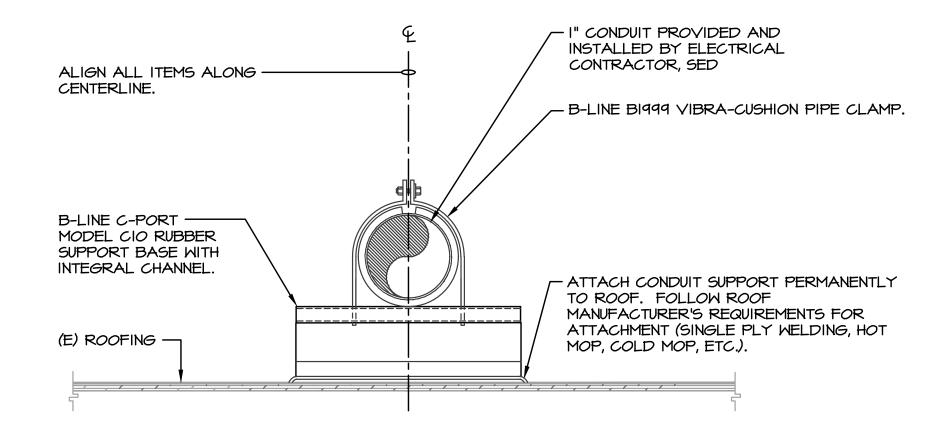

CONDUIT SUPPORT DETAIL

NO SCALE





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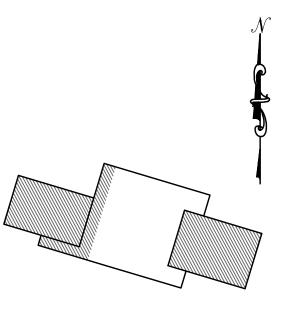
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SHEET NUMBER

M3.1

#### **GENERAL NOTES**

- PLUMBING FLOOR PLANS ARE DIAGRAMMATIC. ALL ABOVE GRADE PIPING SHOWN NEAR A PLUMBING CHASE IS TO BE LOCATED WITHIN THE PLUMBING CHASE, UNLESS OTHERWISE NOTED. OFFSET PIPING AROUND BEAMS, COLUMNS, WALLS, ETC., AS REQUIRED.
- 2. ALL CONDITIONS HAVE BEEN SHOWN AS ACCURATELY AS POSSIBLE. CONTRACTOR IS TO INCLUDE IN HIS BID ADJUSTMENTS TO THE WORK AS REQUIRED TO ACCOMODATE THE ACTUAL FIELD CONDITIONS.
- 3. FIELD VERIFY LOCATIONS OF OPENINGS INTO BUILDINGS AND AIR CONDITIONING (A/C) UNIT OUTSIDE AIR INTAKES. VENT PIPING TERMINATIONS IN ALL CASES ARE TO BE A MINIMUM OF TEN (IO) FEET FROM OPENINGS INTO BUILDINGS AND A/C UNIT OUTSIDE AIR INTAKES; OFFSET PIPING AS REQUIRED. ALL VENT PIPING SUPPORTS, ETC., NECESSARY TO MEET THIS REQUIREMENT ARE TO BE INCLUDED.
- 4. ALL HORIZONAL CONDENSATE DRAINAGE PIPING SHALL MAINTAIN A MINIMUM 2% SLOPE TO POINT OF DISPOSAL.
- 5. ALL HORIZONTAL WASTE PIPING SHALL MAINTAIN A MINIMUM 2% SLOPE TO POINT
- 6. ALL CORING AND PENETRATIONS OF WALLS AND/OR FLOORS FOR PIPING ARE TO BE AS SMALL AS POSSIBLE. OVERSIZING OF OPENINGS IS TO BE AVOIDED. WALL PENETRATIONS ARE TO BE COORDINATED WITH ALL OTHER TRADES AND THE DRAWINGS. WALL PENETRATIONS ARE TO BE KEPT AS HIGH AS POSSIBLE AND ARE TO BE MADE IN AREAS WHERE PIPING WILL BE CONCEALED. IF PENETRATIONS IN EXPOSED LOCATIONS ARE UNAVOIDABLE, INSTALL ESCUTCHEON RINGS AT THESE LOCATIONS.
- 7. FIRE CAULK ALL PENETRATIONS THROUGH FIRE RATED WALLS WITH 3M FIRE STOPPING SYSTEMS, OR EQUAL.

#### MECHANICAL AND PLUMBING COMPONENT ANCHORAGE NOTE

ALL MECHANICAL AND PLUMBING COMPONENTS SHALL BE ANCHORED AND INSTALLED PER THE DETAILS ON THE CONSTRUCTION DOCUMENTS. WHERE NO DETAIL IS INDICATED, THE FOLLOWING COMPONENTS SHALL BE ANCHORED OR BRACED TO MEET THE FORCE AND DISPLACEMENT REQUIREMENTS PRESCRIBED IN THE 2016 CBC, SECTIONS 1616A.1.18 THROUGH 1616A.I.26 AND ASCE 7-10 CHAPTERS 13, 26 AND 30.

- ALL PERMANENT EQUIPMENT AND COMPONENTS.
- 2. TEMPORARY OR MOVABLE EQUIPMENT THAT IS PERMANENTLY ATTACHED TO THE BUILDING UTILITY SERVICES SUCH AS GAS OR WATER PIPING.
- 3. MOVABLE EQUIPMENT WHICH IS STATIONED IN ONE PLACE FOR MORE THAN & HOURS AND HEAVIER THAN 400 POUNDS OR HAS A CENTER OF MASS LOCATED 4 FEET OR MORE ABOVE THE ADJACENT FLOOR OR ROOF LEVEL THAT DIRECTLY SUPPORT THE COMPONENT ARE REQUIRED TO BE ANCHORED WITH TEMPORARY ATTACHMENTS.

THE FOLLOWING MECHANICAL COMPONENTS SHALL BE POSITIVELY ATTACHED TO THE STRUCTURE, BUT THE ATTACHMENT NEED NOT BE DETAILED ON THE PLANS. THESE COMPONENTS SHALL HAVE FLEXIBLE CONNECTIONS PROVIDED BETWEEN THE COMPONENT AND ASSOCIATED DUCTWORK AND PIPING.

- A. COMPONENTS WEIGHING LESS THAN 400 POUNDS AND HAVE A CENTER OF MASS LOCATED 4 FEET OR LESS ABOVE THE ADJACENT FLOOR OR ROOF LEVEL THAT DIRECTLY SUPPORT THE COMPONENT.
- B. COMPONENTS WEIGHING LESS THAN 20 POUNDS, OR IN THE CASE OF DISTRIBUTED SYSTEMS, LESS THAN 5 POUNDS PER FOOT, WHICH ARE SUSPENDED FROM A ROOF OR FLOOR OR HUNG FROM A WALL.

FOR THOSE ELEMENTS THAT DO NOT REQUIRE DETAILS ON THE APPROVED DRAWINGS, THE INSTALLATION SHALL BE SUBJECT TO THE APPROVAL OF THE DESIGN PROFESSIONAL IN GENERAL RESPONSIBLE CHARGE OR STRUCTURAL ENGINEER DELEGATED RESPONSIBILITY. THE PROJECT INSPECTOR WILL VERIFY THAT ALL COMPONENTS AND EQUIPMENT HAVE BEEN ANCHORED IN ACCORDANCE WITH ABOVE

#### PIPING AND DUCTWORK SYSTEMS BRACING NOTE

PIPING AND DUCTWORK SYSTEMS SHALL BE BRACED TO COMPLY WITH THE FORCES AND DISPLACEMENTS PRESCRIBED IN ASCE 7-10 SECTION 13.3 AS DEFINED IN ASCE 7-10 SECTIONS 13.6.5.6, 13.6.7, 13.6.8, AND 2016 CBC SECTIONS 1616A.1.24, 1616A.1.25 AND 1616A.1.26.

THE METHOD OF SHOWING BRACING AND ATTACHMENTS TO THE STRUCTURE FOR THE IDENTIFIED DISTRIBUTION SYSTEM ARE AS NOTED BELOW. WHEN BRACING AND ATTACHMENTS ARE BASED ON A PREAPPROVED INSTALLATION GUIDE (E.G., SMACNA OR OSHPD OPM), COPIES OF THE BRACING SYSTEM INSTALLATION GUIDE OR MANUAL SHALL BE AVAILABLE ON THE JOBSITE PRIOR TO THE START OF AND DURING THE HANGING AND BRACING OF THE DISTRIBUTION SYSTEMS. THE STRUCTURAL ENGINEER OF RECORD SHALL VERIFY THE ADEQUACY OF THE STRUCTURE TO SUPPORT THE HANGER AND BRACE LOADS.

MECHANICAL PIPING (MP), MECHANICAL DUCTS (MD) AND PLUMBING PIPING (PP):

MP 🗆 MD 🗆 PP 🗆 👚 -MP 🗆 MD 🗆 PP 🗆 👚 - OPTION I: DETAILED ON THE APPROVED DRAWINGS WITH PROJECT SPECIFIC NOTES AND DETAILS. OPTION 2: SHALL COMPLY WITH THE APPLICABLE OSHPD PRE-APPROVAL (OPM #0052-13). OPTION 3: SHALL COMPLY WITH SMACNA SEISMIC RESTRAINT MANUAL, OSHPD EDITION (2009), INCLUDING ANY ADDENDA. FASTNERS AND OTHER ATTACHMENTS NOT SPECIFICALLY IDENTIFIED IN THE SMACNA SEISMIC RESTRAINT MANUAL, OSHPD EDITION, ARE DETAILED ON THE APPROVED DRAWINGS WITH PROJECT SPECIFIC NOTES AND DETAILS. THE DETAILS SHALL ACCOUNT FOR THE APPLICABLE SEISMIC HAZARD LEVEL AND CONNECTION LEVEL FOR THE PROJECT AND CONDITIONS.

#### PLUMBING LEGEND AND ABBREVIATIONS

ABBREVIATION DESCRIPTION

GC, G.C. GENERAL CONTRACTOR

<u>SYMBOL</u>	<u>ABBREVIATION</u>	DESCRIPTION
4		SHEET NOTE DESIGNATION
M		ITEM FURNISHED AND INSTALLED BY MECHANICAL CONTRACTOR
E		ITEM FURNISHED AND INSTALLED BY ELECTRICAL CONTRACTOR
P		ITEM FURNISHED AND INSTALLED BY PLUMBING CONTRACTOR
P2.I		DETAIL REFERENCE - UPPER NUMBER=DETAIL NUMBER, LOWER NUMBER=SHEET NUMBER
CD	CD	CONDENSATE DRAIN PIPING
	6	NATURAL GAS PIPING
	(E)G	EXISTING NATURAL GAS PIPING TO REMAIN
	BV	BALL VALVE
——————————————————————————————————————		UNION
$-\!-\!$		CHANGE IN PIPE SIZE
		EXISTING FIXTURES, PIPING OR EQUIPMENT TO REMAIN
		EXISTING FIXTURES, PIPING OR EQUIPMENT TO BE REMOVED

Φ	DIAMETER	<i>G</i> SM	GALVANIZED SHEET METAL
Φ	PHASE	U5 ™ H <b>¢</b> √	HEATING & VENTILATING
	AIR CONDITIONING	HT.	HEIGHT
AC, A/C AFF	ABOVE FINISHED FLOOR	πι. IE, I.E.	INVERT ELEVATION (FT.)
ALT.	ALTERNATE	IFC	IN FURRED CEILING / ABOVE FINISHED
AP	ACCESS PANEL	11 0	CEILING
APPROX.	APPROXIMATE	IN.	INCHES
BF	BELOW FLOOR	IND.	INDIRECT
BFF	BELOW FINISHED FLOOR	INV	INVERT
B <i>G</i>	BELOW GRADE	LBS., #	POUNDS
BLDG.	BUILDING	MAX.	MAXIMUM
BV	BALL VALVE	MECH.	MECHANICAL
CFH CFH	CUBIC FEET PER HOUR	MFG.	MANUFACTURER
	CENTERLINE	MIN.	MINIMUM
4 Cl	CAST IRON	(N)	NEW
CKY	CHECK VALVE	00	ON CENTER
CLG	CEILING	OFCI	OWNER FURNISHED / CONTRACTOR INSTALLED
co	CLEANOUT	OPER.	OPERABLE
ARCH.	COMPARTMENT	PC, P.C.	PLUMBING CONTRACTOR
CONC.	CONCRETE	PLMB.	PLUMBING
CONN.	CONNECT, CONNECTION	P.O.C.	POINT OF CONNECTION
CONT.	CONTINUATION	PRESS.	PRESSURE
CONTR.	CONTRACTOR	PSI, PSI.	POUNDS PER SQUARE INCH
CTE	CONNECT TO EXISTING	P/T	PRESSURE/TEMPERATURE
DEMO	DEMOLITION	REF.	REFERENCE
DIA.	DIAMETER	REQD.	REQUIRED
DIM.	DIMENSION	REV.	REVISION
DIR.	DIRECT	SCH 40, 80	SCHEDULE 40 OR 80 PIPE
DN	DOWN	SED	SEE ELECTRICAL DRAWINGS
DMG	DRAWING	S.F., SF	SQUARE FEET
DWGS.	DRAWINGS	SM	SHEET METAL
(E)	EXISTING	SMD	SEE MECHANICAL DRAWINGS
ELEC.	ELECTRICAL	50V	SHUT-OFF VALVE
ELEV.	ELEVATION	<del>55</del>	SANITARY SEWER
EMBED.	EMBEDMENT	T&P	TEMPERATURE AND PRESSURE
EQ.	EQUAL	TYP, TYP.	TYPICAL
EST.	ESTIMATED	U/C	UNDER COUNTER
EXIST.	EXISTING	UNO	UNLESS OTHERWISE NOTED
FF, F.F.	FINISHED FLOOR	VIF	VERIFY IN FIELD
F.H.	FLAT HEAD	MC	WATER COLUMN (PRESS.)
FIN.	FINISHED	MOG	MATER OIL GAS
F & I	FURNISHED AND INSTALLED	MT.	WEIGHT
FT.	FEET		
FU	FIXTURE UNITS		
GA.	GAUGE		
<i>6</i> C, <i>6</i> .C.	GAS COCK		

ABBREVIATION DESCRIPTION

#### PLUMBING LIST OF DRAWINGS

- PO.I PLUMBING LEGEND AND NOTES
- PI.I PLUMBING DEMOLITION ROOF PLAN
- P2.I PLUMBING ROOF PLAN P3.I PLUMBING DETAILS




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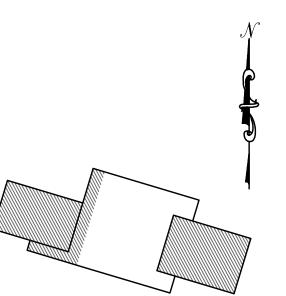
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PLUMBING LEGEND **NOTES AND** SCHEDULES

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7) PLEASE RECYCLE

- I. (E) ROOF MOUNTED AC UNIT TO BE REMOVED IN PREPARATION FOR THE INSTALLATION OF A (N) UNIT IN A SIMILAR LOCATION, SEE MECHANICAL DRAWINGS.
- 2. REMOVE (E) 2"G, VALVES, SUPPORTS AND ALL RELATED ACCESSORIES IN PREPARATION FOR (N) GAS PIPING TO BE CONNECTED TO THE (N) AC UNIT.
- 3. (E) ROOF MOUNTED H&V UNIT TO BE REMOVED IN PREPARATION FOR THE INSTALLATION OF A (N) UNIT IN A SIMILAR LOCATION, SEE MECHANICAL DRAWINGS.
- 4. REMOVE (E) 3/4"G, VALVES, SUPPORTS AND ALL RELATED ACCESSORIES IN PREPARATION FOR (N) GAS PIPING TO BE CONNECTED TO (N) H&V UNIT.
- 5. (E) ROOF MOUNTED GAS PIPING, FIELD VERIFY ACTUAL SIZE AND LOCATION OF (E) PIPING.



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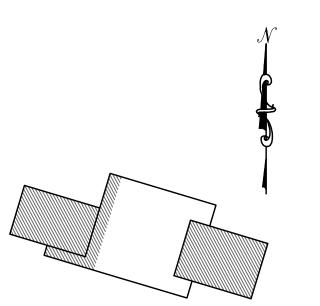
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Key Plan
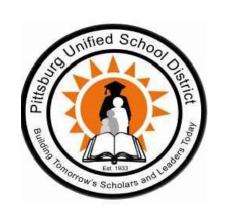
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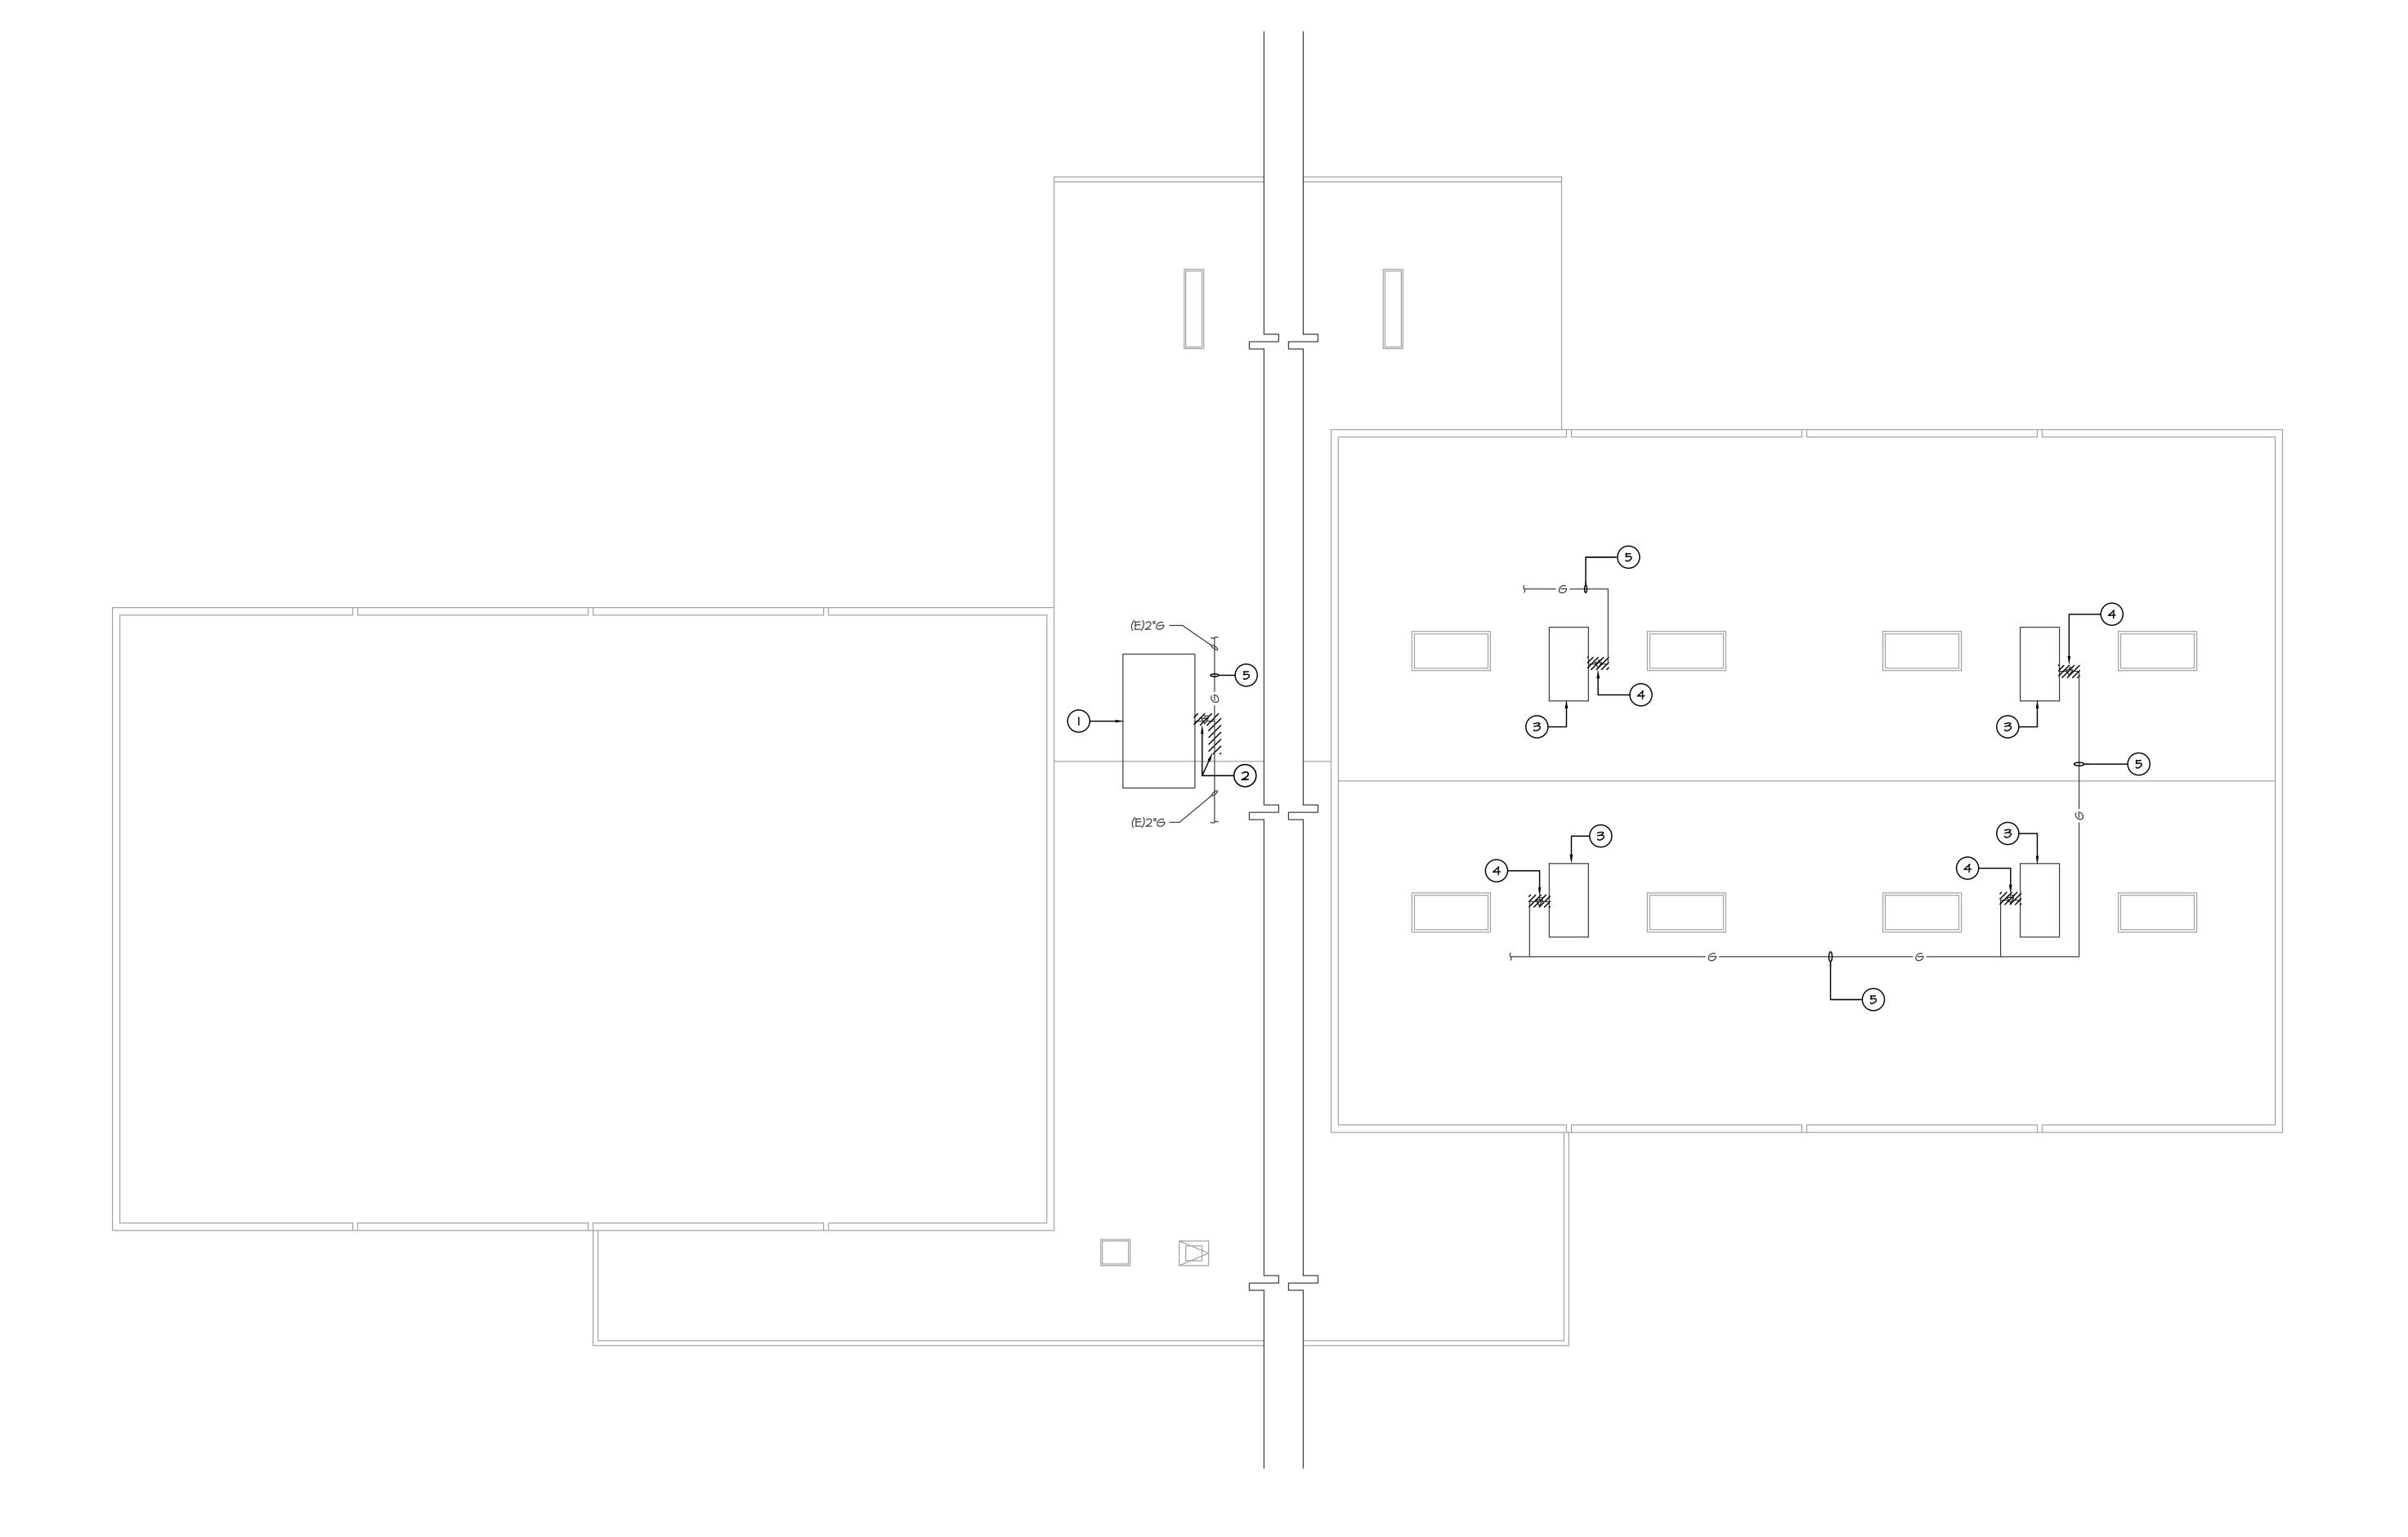
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ET	05.22.2017

PLUMBING DEMOLITION ROOF PLAN

SHEET NUMBER

P1.1

SHEET TITLE



PLUMBING DEMOLITION ROOF PLAN

SCALE: 1/8" = 1'-0"



- I. (E) ROOF MOUNTED GAS PIPING, FIELD VERIFY ACTUAL SIZE AND LOCATION OF (E) PIPING.
- (N) AC UNIT AND TRANSITION CURB MOUNTED ON (E) ROOF CURB, SEE MECHANICAL DRAWINGS.
- (N) H&V UNIT MOUNTED ON (E) ROOF CURB. SEE MECHANICAL DRAWINGS.
- 4. CONNECT (N) GAS PIPE TO MATCH SIZE OF (E) GAS PIPING. ESTIMATED SIZE OF (E) GAS PIPING IS 2". SEE 4/P3.I FOR GAS PIPE MOUNTING ON ROOF.
- 5. CONNECT (N) 2"G TO (N) AC UNIT, SEE 1/P3.1.
- 6. CONNECT (N) GAS PIPE TO MATCH SIZE OF (E) GAS PIPING. SEE 4/P3.1 FOR GAS PIPE MOUNTING ON ROOF.
- 7. CONNECT (N) 1-1/2"G TO (N) H&V UNIT, SEE 1/P3.1.
- 8. CONNECT I"CD TO (N) AC UNIT, SEE 2/P3.I.
- 9. I"CD MOUNTED ON ROOF, SEE 3/P3.I.
- IO. TERMINATE I"CD WITH ELBOW TO DRAIN INDIRECTLY INTO (E)
  DOWNSPOUT AT GUTTER. FIELD VERIFY ACTUAL LOCATION
  OF (E) DOWNSPOUT.





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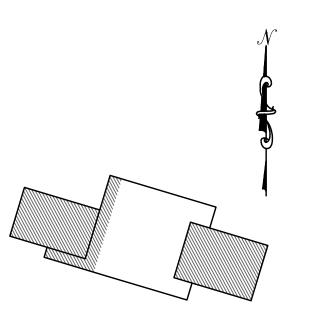
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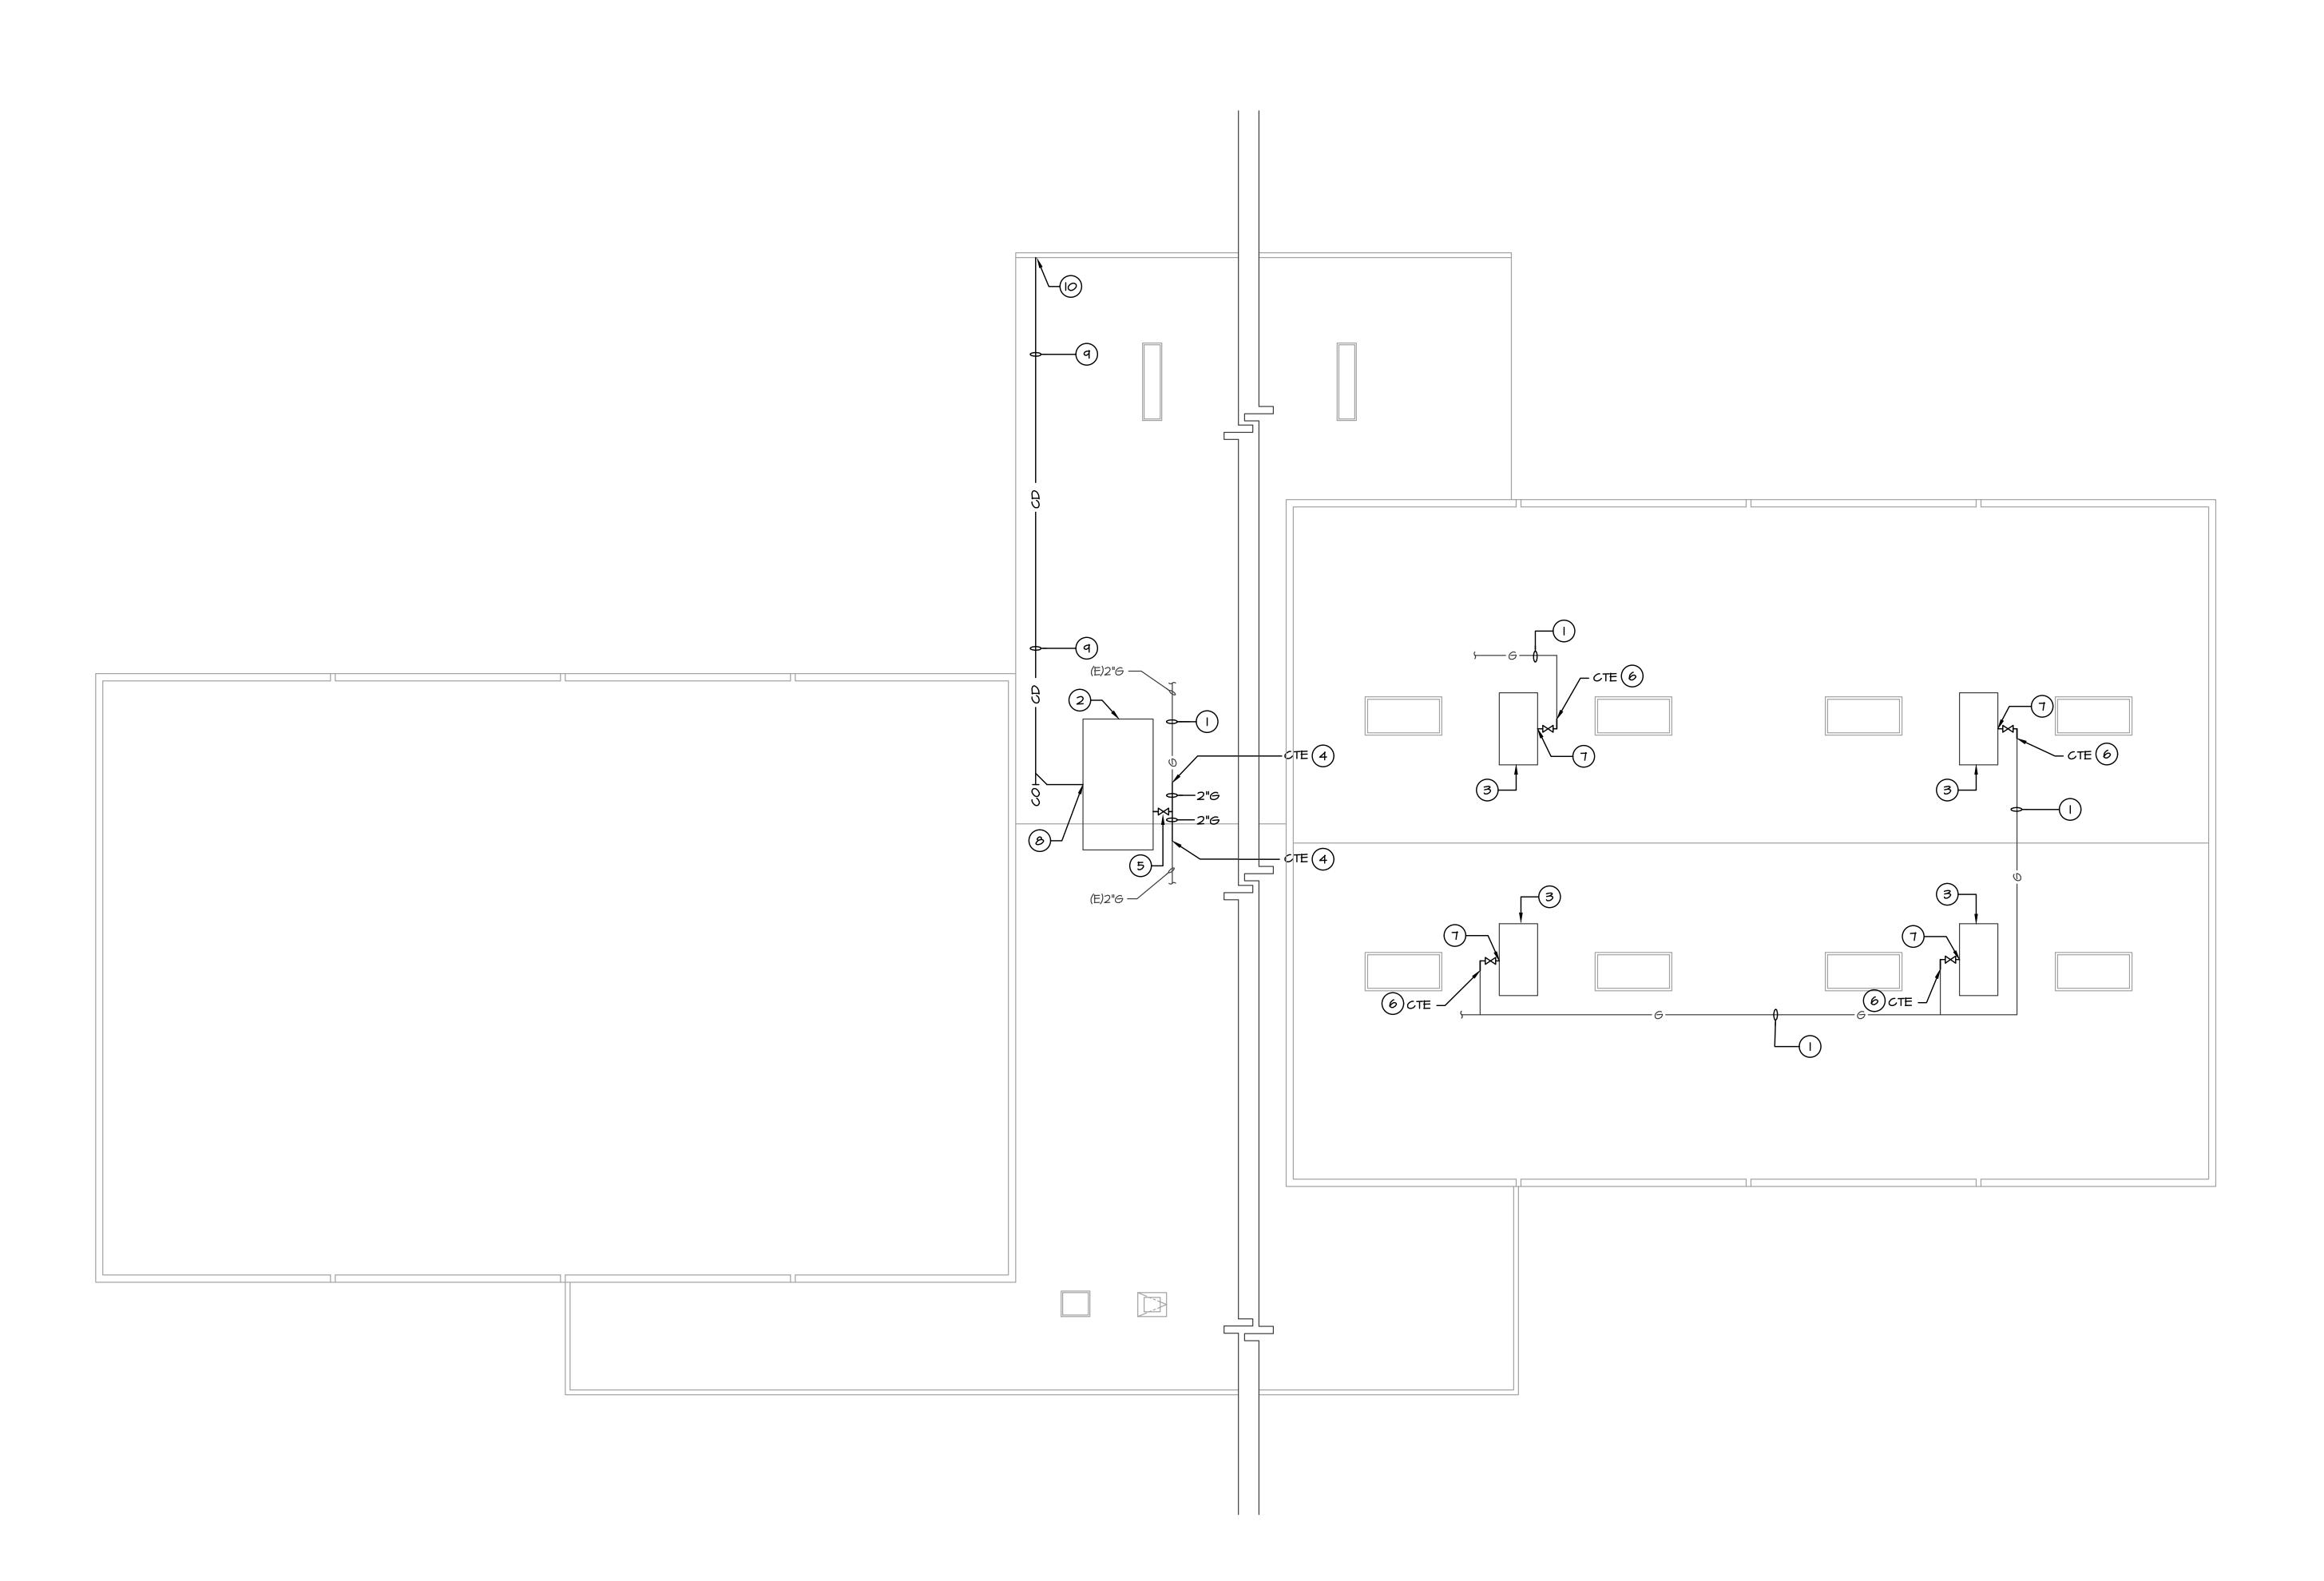
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**PLUMBING ROOF PLAN** 

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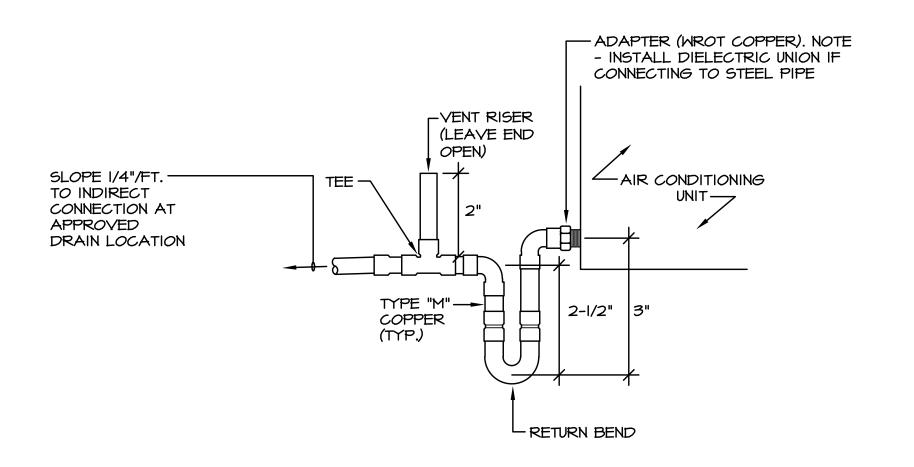
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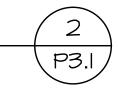
PLUMBING ROOF PLAN

SCALE: 1/8" = 1'-0"






CONDENSATE DRAIN PIPING CONNECTION DETAIL NO SCALE



- GAS SHUTOFF VALVE. SIZE TO MATCH LINE SIZE SHOWN ON DRAWINGS. AGA APPROVED, CONNECTION SIZE FULL PORT, 600 PSI WOG BALL VALVE. RED WHITE #5044F OR GAS SUPPLY PIPING -SEE DRAWING FOR SIZE -6" DIRT LEG WITH CAP


GAS PIPING CONNECTION DETAIL

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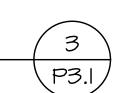


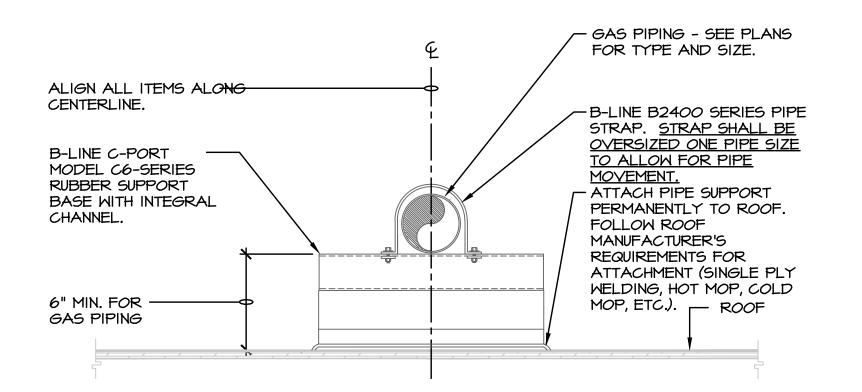GAS PIPE SUPPORT DETAIL NO SCALE



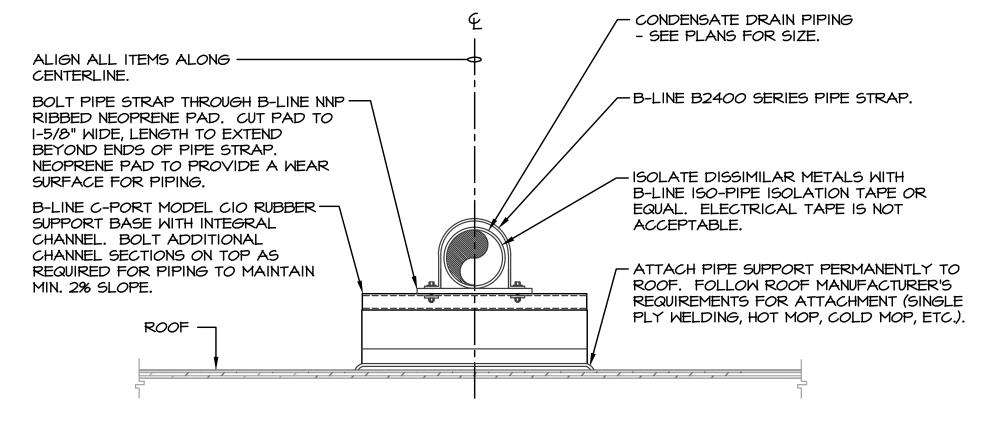

CONDENSATE DRAIN PIPING SUPPORT DETAIL NO SCALE



\P3.I

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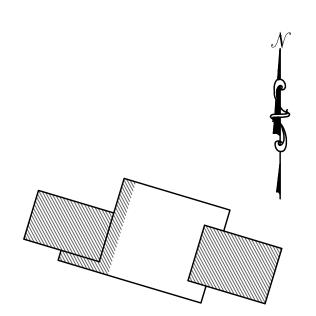
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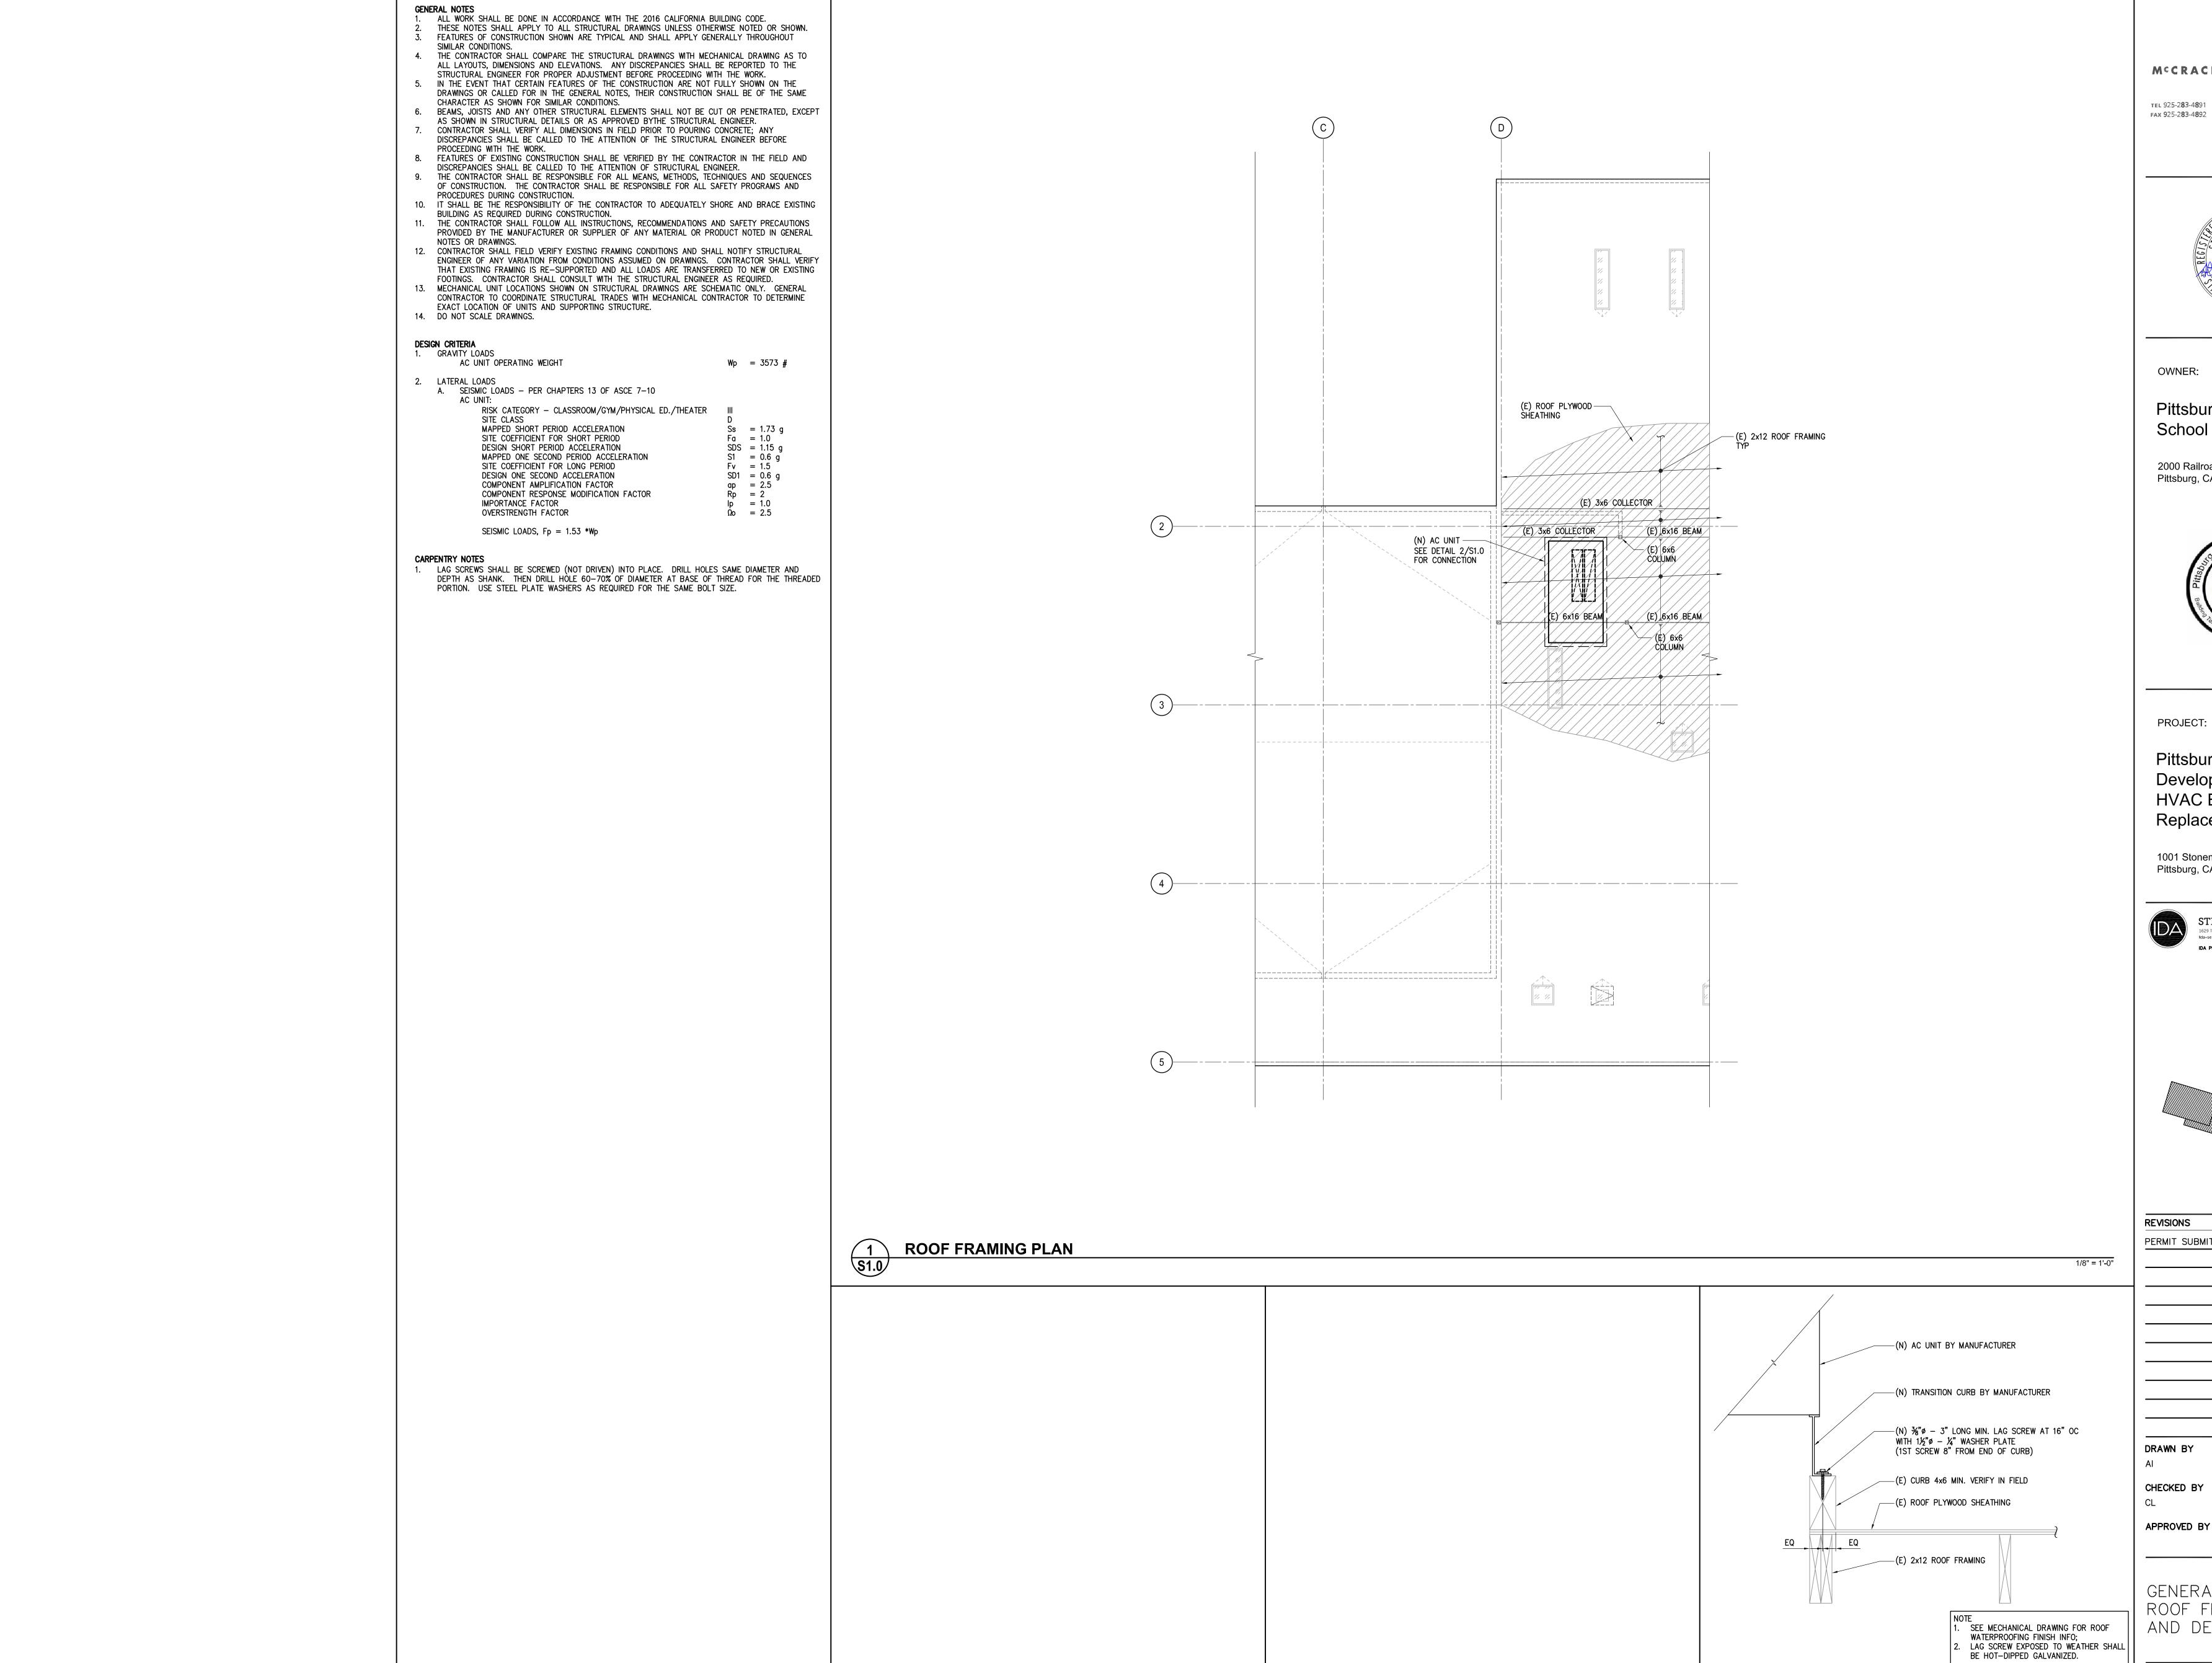
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#### Pittsburg Unified **School District**

2000 Railroad Avenue Pittsburg, CA 94565




PROJECT:

Pittsburg Youth Development Center -**HVAC** Equipment Replacement

1001 Stoneman Ave Pittsburg, CA 94565



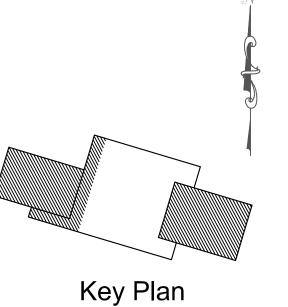

REVISIONS	DATE
PERMIT SUBMITTAL	05.22.2017

05.22.2017 SCALE

CHECKED BY

JOB NUMBER 1717 SHEET TITLE

GENERAL NOTES ROOF FRAMING PLAN AND DETAIL


SHEET NUMBER

AS NOTED

PLEASE RECYCLE

TRANSITION CONNECTION DETAIL


#### SYMBOLS LIST

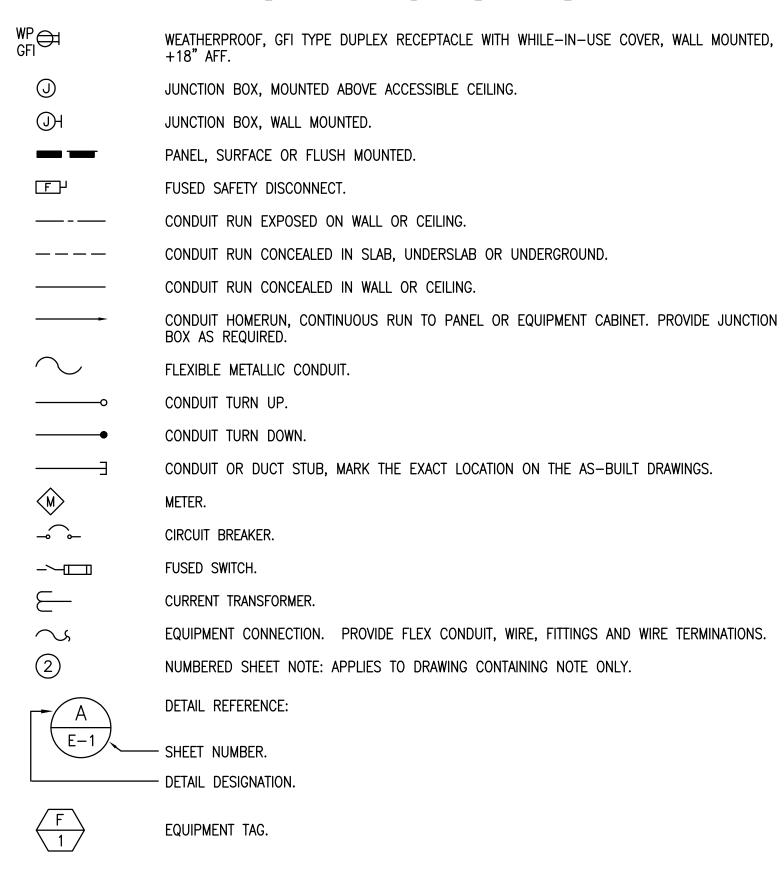


#### DRAWING LIST

- SYMBOLS, NOTES AND DIAGRAMS.
- POWER PLAN GYMNASIUM AND COMMUNITY ROOM.
- ROOF ELECTRICAL PLAN.

#### **ABBREVIATIONS**

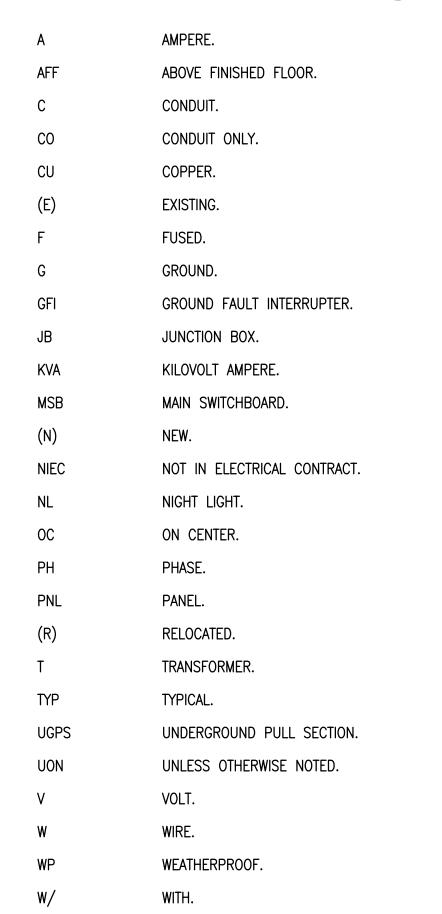

MOUNT 48" ABOVE FINISHED FLOOR FROM THE CENTER LINE OF DEVICE.

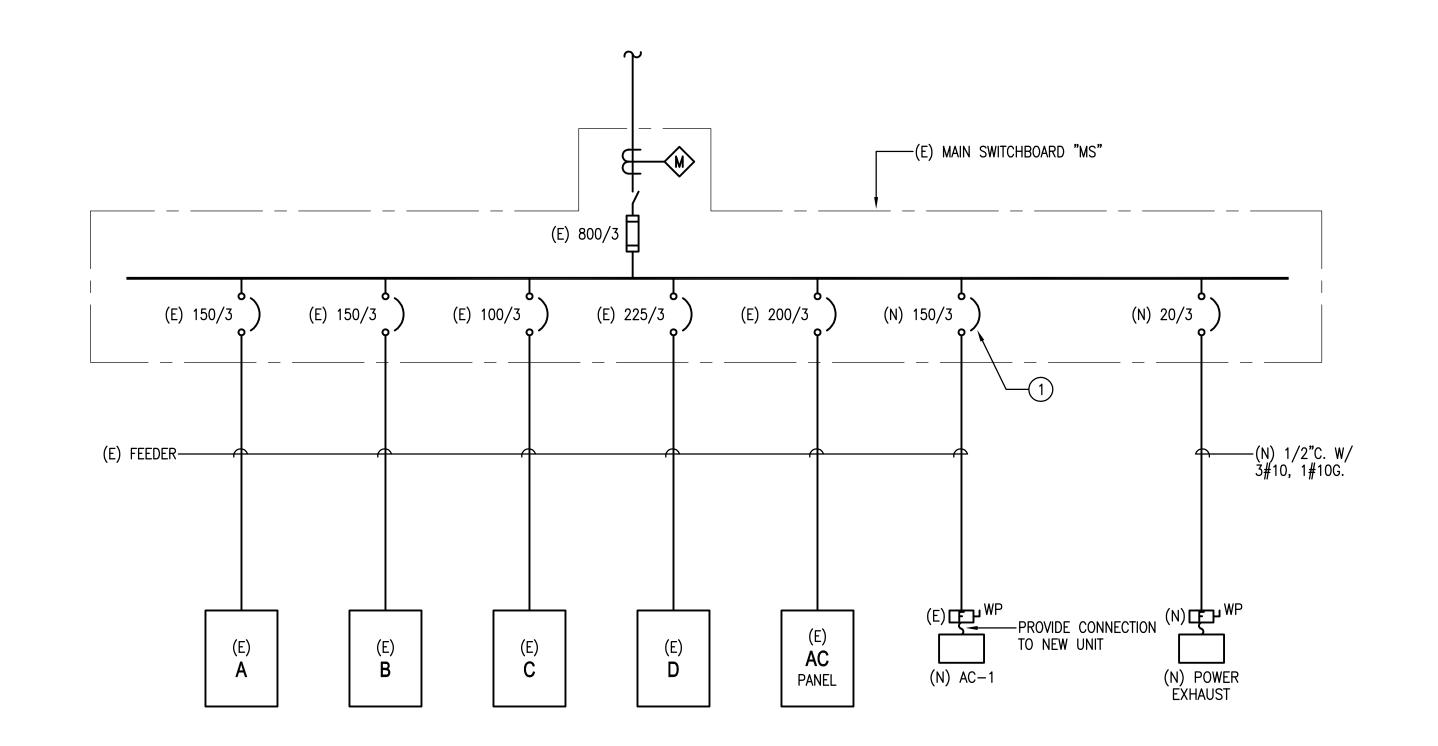

#### NUMBERED SHEET NOTES:

REPLACE EXISTING CIRCUIT BREAKER WITH NEW BREAKER AS SHOWN. CIRCUIT BREAKER SHALL HAVE INTERRUPTING CAPACITY TO MATCH EXISTING.





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Pittsburg Unified School District

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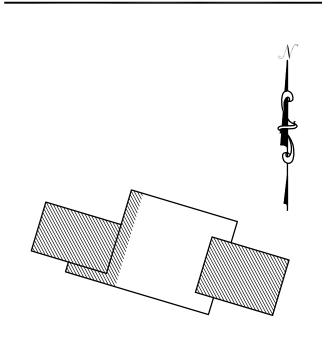


PROJECT:

Pittsburg Youth Development Center -**HVAC** Equipment Replacement

1001 Stoneman Ave Pittsburg, CA 9565

REVISIONS



Key Plan

DATE


DRAWN BY	DATE <i>0</i> 5-22-17
CHECKED BY	SCALE N.T.S.
APPROVED BY	JOB NUMBER

SHEET TITLE SYMBOLS, NOTES AND DIAGRAMS

SHEET NUMBER

E-1

PLEASE RECYCLE

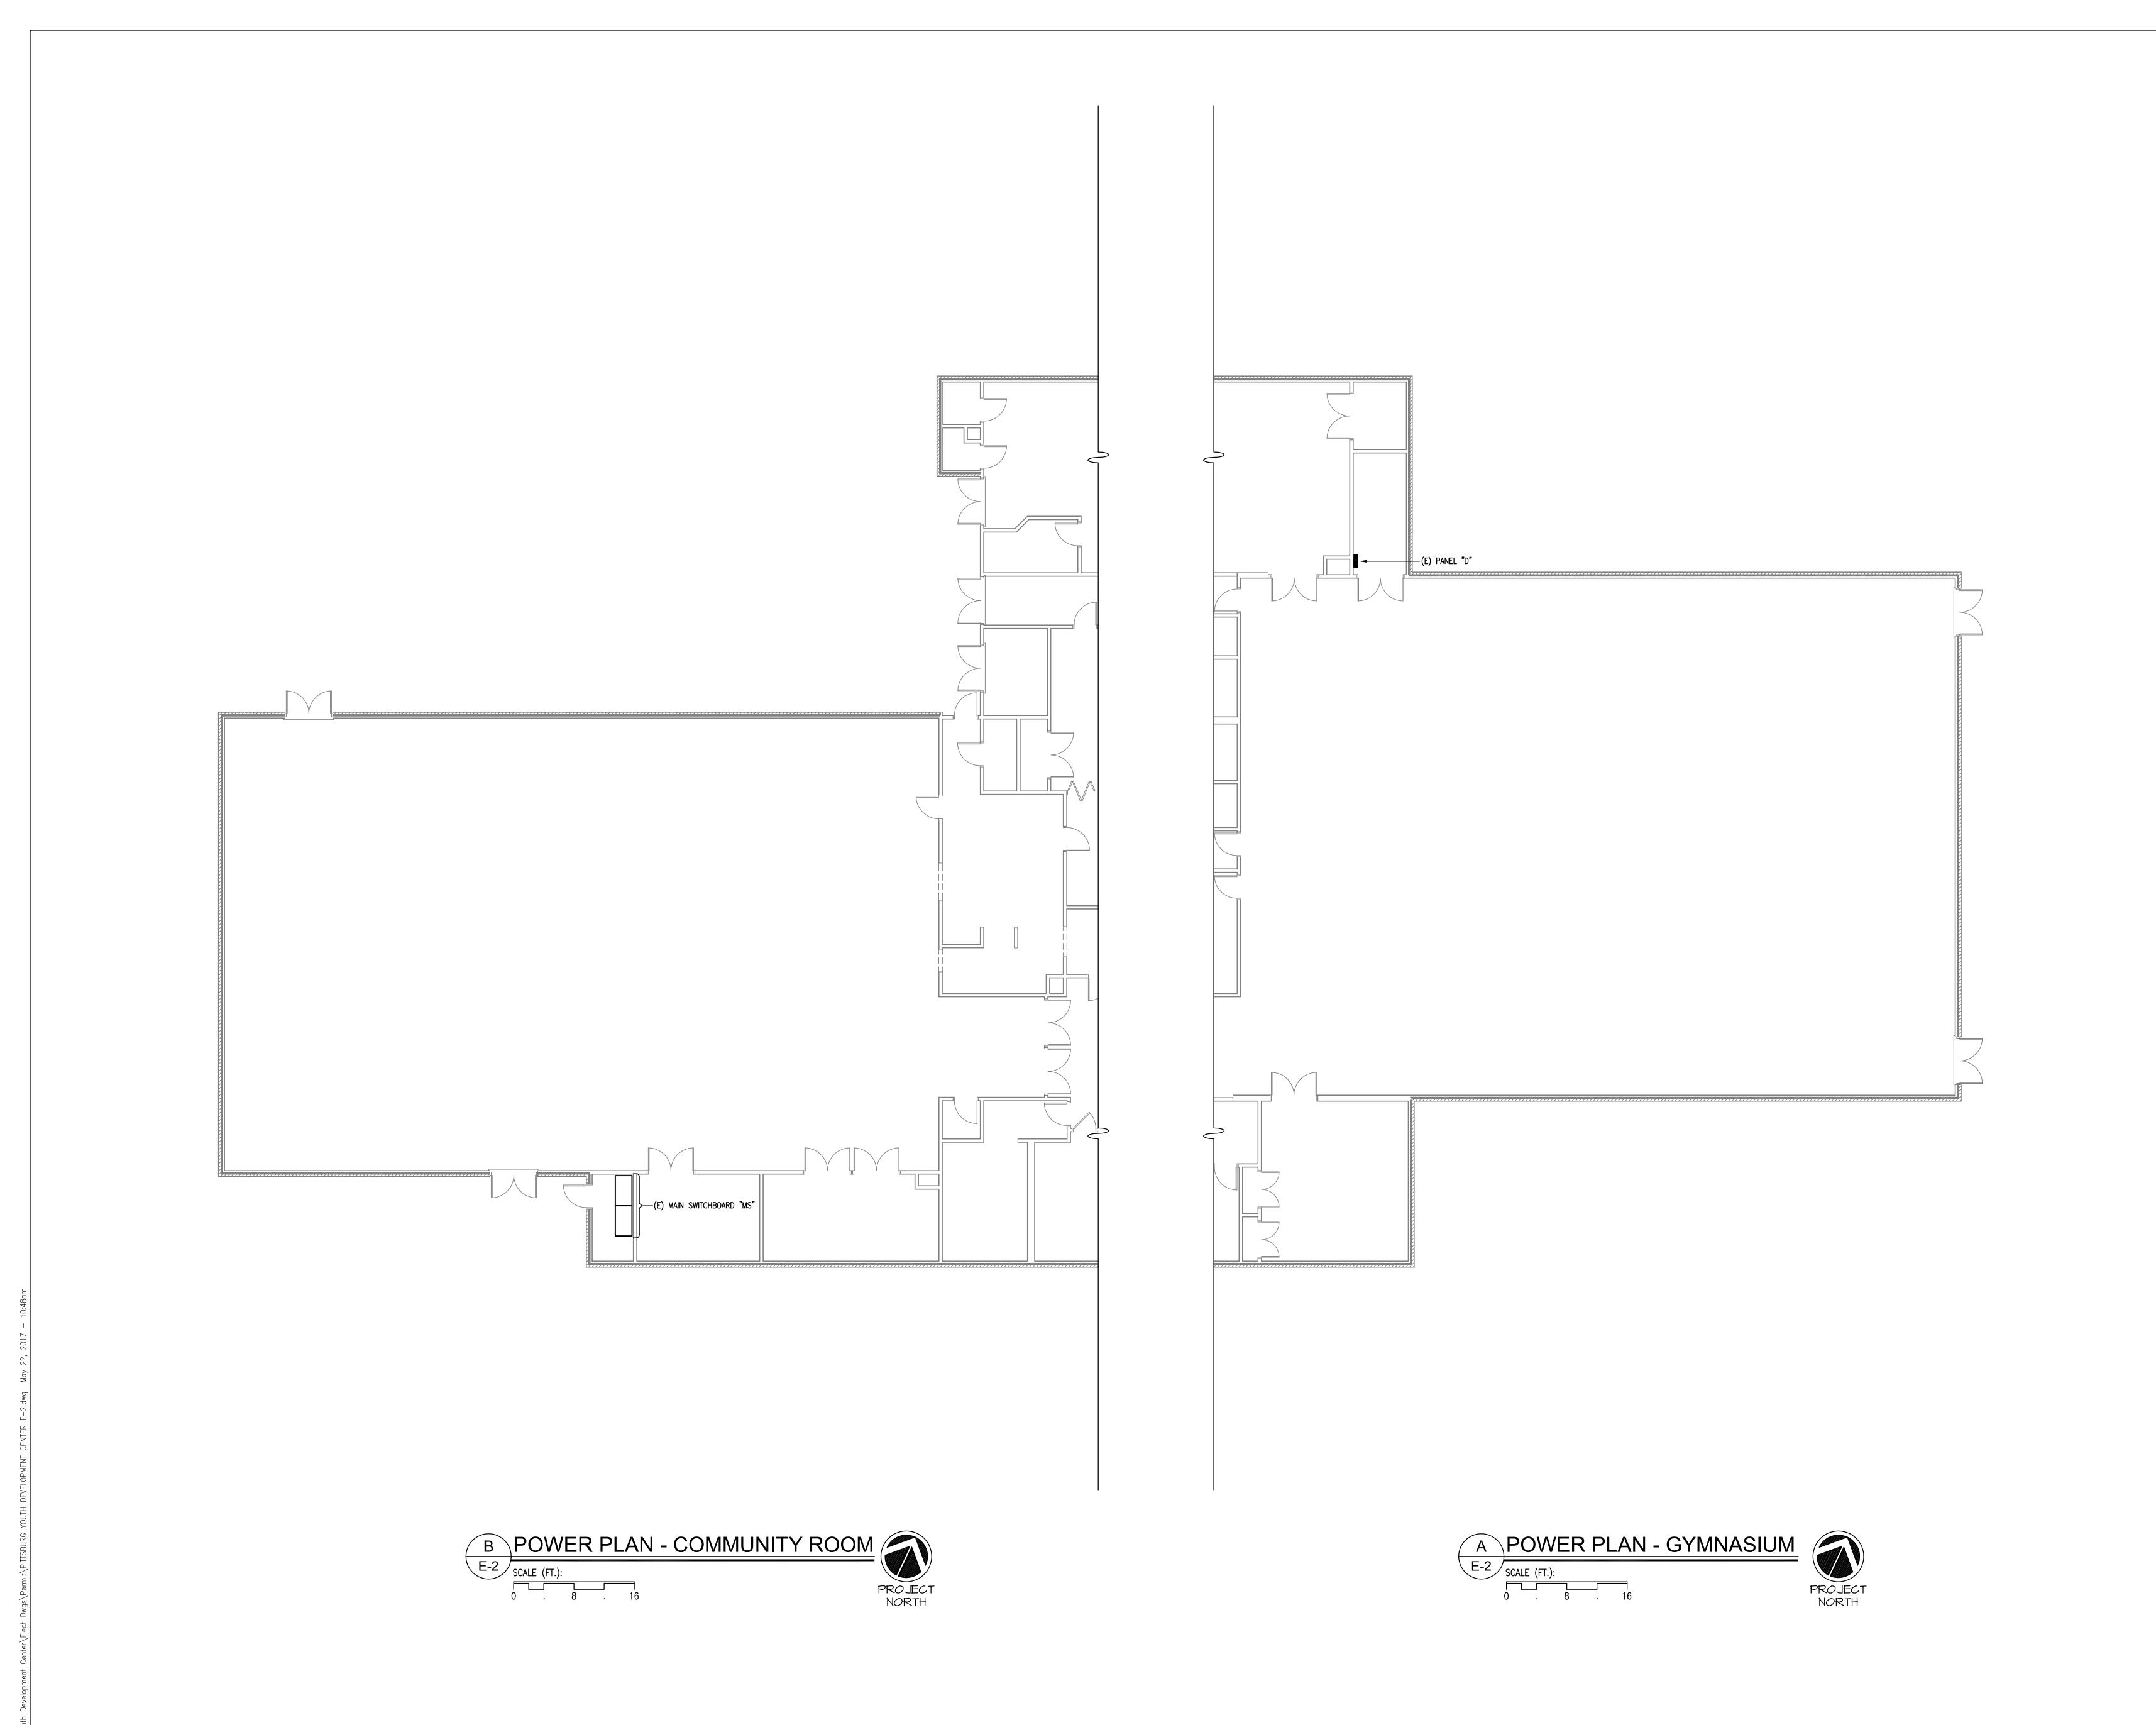



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TEL 925-283-4891 3470 Mt. Diablo Blvd, Suite A305 FAX 925-283-4892 Lafayette, CA 94549

ASSOCIATES, INC.

ELECTRICAL ENGINEERING

1290 B Street, Suite 209
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OWNE

Pittsburg Unified School District


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PROJECT:

Pittsburg Youth
Development Center HVAC Equipment
Replacement

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Key Plan

REVISIONS

DATE
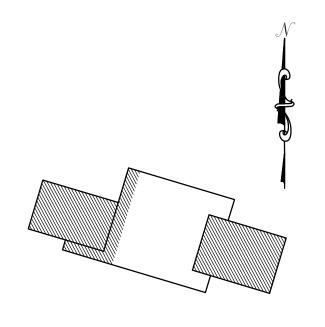
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MD	05-22-17
CHECKED BY	SCALE

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APPROVED BY


JOB NUMBER

POWER PLAN -GYMNASIUM AND COMMUNITY ROOM

SHEET NUMBER

E-2

SHEET TITLE

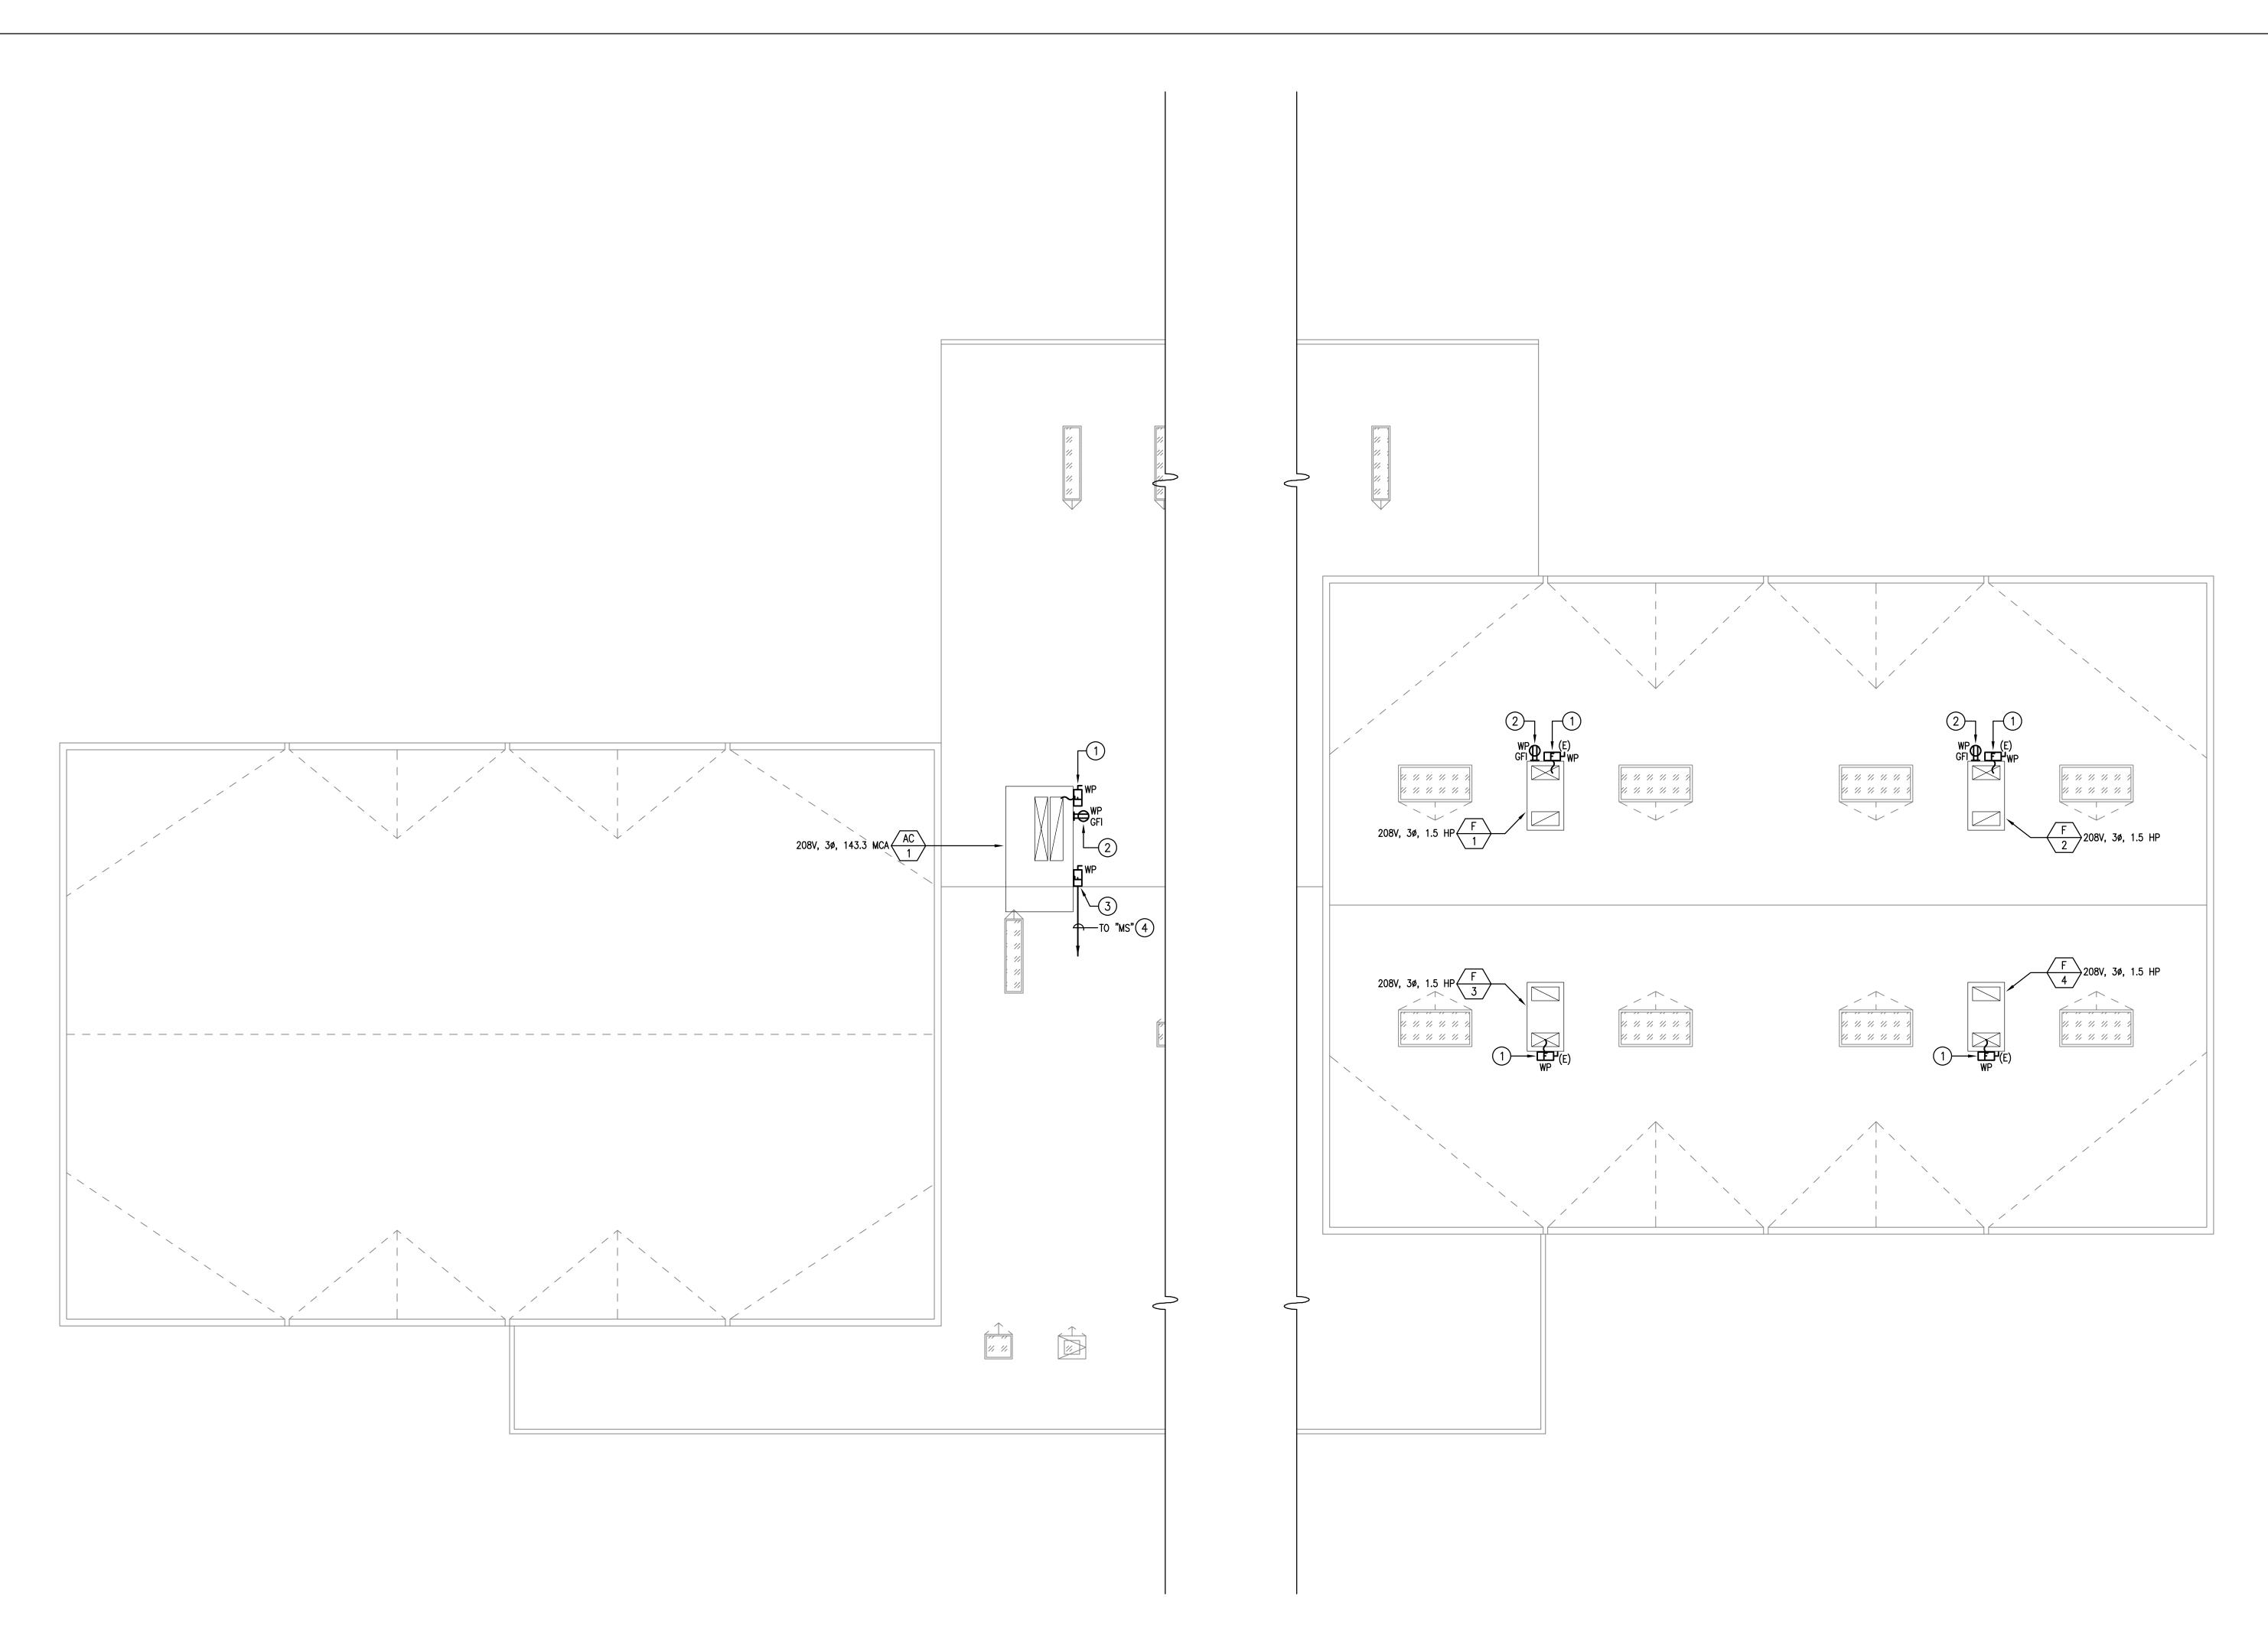


#### NUMBERED SHEET NOTES:

- DISCONNECT POWER TO EXISTING UNIT DURING THE EXISTING UNIT REMOVAL AND RECONNECT TO NEW UNIT USING EXISTING FUSED DISCONNECT SWITCH AND BRANCH CIRCUIT WIRES. PROVIDE NEW FUSED DISCONNECT SWITCH PER MANUFACTURER'S RECOMMENDATIONS.
- 2 REMOVE EXISTING DUPLEX RECEPTACLE AND REPLACE WITH A NEW GFI TYPE, WEATHERPROOF RECEPTACLE AND WHILE-IN-USE COVER PLATE. RECONNECT NEW RECEPTACLE TO EXISTING CIRCUIT.
- 3 PROVIDE POWER CONNECTION TO POWER EXHAUST FAN. COORDINATE EXACT LOCATION WITH MECHANICAL CONTRACTOR. PROVIDE FUSES IN ACCORDANCE WITH THE MANUFACTURER'S RECOMMENDATIONS.
- 4 REFER TO ONE LINE DIAGRAM FOR FEEDER SIZE.

### GENERAL SHEET NOTES:

- 1. PROVIDE 1/2" EMPTY CONDUIT WITH PULL WIRE FOR HVAC CONTROL WIRING AT ALL EXTERIOR LOCATIONS AND EXPOSED LOCATIONS WITHIN THE BUILDING. COORDINATE EXACT LOCATIONS WITH THE MECHANICAL CONTRACTOR.
- 2. PROVIDE 1" RIGID CONDUIT FOR POWER EXHAUST PRESSURE SENSING TUBING. COORDINATE EXACT REQUIREMENTS AND CONDUIT ROUTING WITH THE MECHANICAL CONTRACTOR. REFER TO DETAIL 3/M3.1 FOR THE SUPPORT OF THE CONDUIT ON THE ROOF.

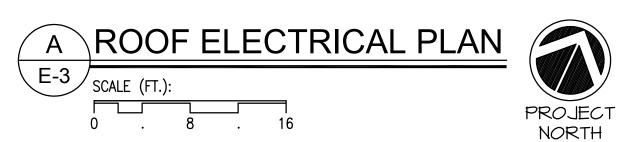



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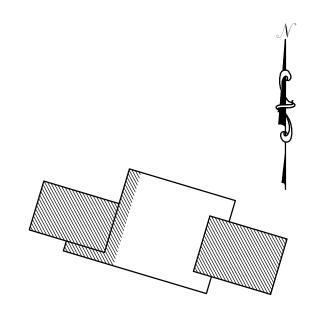
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PROJECT:

Pittsburg Youth
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Key Plan

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JOB NUMBER

MM
1717

ROOF ELECTRICAL PLAN

SHEET NUMBER

E-3